



# **ROAD REHABILITATION** AUSTIN AVE., DANSEY AVE. & KARP CT. ISSUED FOR TENDER

NTS

	DRAWING SCHEDULE			
G. NO.	SHEET TITLE	DESCRIPTION		
00	COVER SHEET			
01	GENERAL NOTES			
02	AUSTIN AVENUE	GATENSBURY ST. TO SCHOOLHOUSE ST.		
03	DANSEY AVENUE	KARP COURT TO SCHOOLHOUSE ST.		





#201, 3999 Henning Drive, Burnaby, B.C. V5C 6P9 T: (604)629-2696 F: (604)629-2698

## GENERAL NOTES:

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1.	ALL MATERIALS AND CONSTRUCTION SHALL CONFORM TO THE PLATINUM EDITION OF THE MASTER MUNICIPAL CONSTRUCTION DOCUMENTS (MMCD) AND CITY OF COQUITLAM SUPPLEMENTARY SPECIFICATIONS, BYLAWS AND DETAIL DRAWINGS UNLESS OTHERWISE NOTED.	1.	THE CONTRA ETC. AT ALL T FOR ALL CON
2.	THE LOCATION OF EXISTING UTILITIES IS COMPILED FROM OWNER AND UTILITY SUPPLIED RECORD DRAWINGS AND ARE CONSIDERED APPROXIMATE ONLY. THE EXACT LOCATION AND EXTENT OF UTILITIES SHOULD BE DETERMINED BY CONSULTING THE LOCAL AUTHORITIES AND UTILITY		BE CLOSED V OPERATIONS
	COMPANIES CONCERNED. THE CONTRACTOR SHALL VERIFY THE EXACT LOCATION AND INVERT ELEVATION BY HAND OR HYDROVAC EXCAVATION BEFORE CONSTRUCTION OF UTILITY CROSSINGS AND SHALL BE RESPONSIBLE FOR RESTORATION OF ANY DAMAGE TO EXISTING UTILITIES. ANY COSTS ASSOCIATED WITH UTILITY CONFLICTS THAT WERE NOT PRELOCATED WILL BE THE	2.	THE CONTRA UNSUITABLE APPLICABLE
3.	CONTRACTORS RESPONSIBILITY. NOTIFY THE CITY OF COQUITLAM 48 HOURS IN ADVANCE OF ANY CONSTRUCTION OR UTILITY	3.	THE CONTRA HAVE BEEN C
	RELOCATION.	4.	THE CONTRA
4.	REPORT ANY DISCREPANCIES TO THE DESIGN ENGINEER A MIN 72 HOURS PRIOR TO CONSTRUCTION.		CITY OF
5.	RESTORATION OF EXISTING DRIVEWAYS AND WALKWAYS TO CONFORM TO CITY SPECIFICATIONS.		FRANCHI AND MET
6.	BOULEVARDS ARE TO BE CONSTRUCTED TO THE PLATINUM EDITION OF THE MASTER MUNICIPAL CONSTRUCTION DOCUMENTS (MMCD) AND CITY OF COQUITLAM SUPPLEMENTARY SPECIFICATIONS AND DETAIL DRAWINGS UNLESS OTHERWISE SHOWN ON CONTRACT DRAWINGS. BOULEVARDS TO BE SLOPED TO INSPECTION CHAMBERS WHERE APPLICABLE.	5.	THE CONTRA THE WORK. S SHALL BE TAI
7.	EVERY EFFORT IS TO BE MADE TO SAVE EXISTING LANDSCAPING WITHIN THE ROAD R.O.W. LANDSCAPING IS TO BE RESTORED TO ITS ORIGINAL OR BETTER CONDITION. IN THE EVENT OF LANDSCAPING REMOVAL THE PROPERTY OWNER SHALL BE ADVISED OF THE REMOVAL AND THE LANDSCAPING PLACED IN OWNERS PROPERTY UPON THEIR REQUEST.	6.	RESIDENTS D GIVEN 5 DAYS TO DISTRIBU BUSINESSES
8.	ALL SURVEY MONUMENTS WITHIN THE PROJECT BOUNDARIES SHALL BE PROTECTED DURING THE COURSE OF THE WORK. SHOULD ANY SURVEY MONUMENT REQUIRE RAISING OR RELOCATION, THE		RELEASE MA
	CONTRACTOR SHALL NOTIFY THE CITY ENGINEERING AND OPERATIONS DEPARTMENT AT LEAST 72 HOURS IN ADVANCE OF SCHEDULING WORK. ALL DISTURBED MONUMENTS WILL BE REPLACED BY A B.C. LAND SURVEYOR AT THE CONTRACTOR'S EXPENSE.	7.	A TRAFFIC AN PRIOR TO TH
9.	SURVEY PINS DISTURBED DURING THE COURSE OF CONSTRUCTION SHALL BE REPLACED BY A B.C. LAND SURVEYOR AT THE CONTRACTOR'S EXPENSE.	8.	APPROVALS SHALL BE OB
10.	ALL PUBLIC ROADWAYS AFFECTED BY THE WORKS SHALL BE KEPT IN A CLEAN STATE AT ALL TIMES. DUST CONTROL MEASURES SHALL ALSO BE EMPLOYED DURING THE COURSE OF THE WORK.	9.	CONTRACTO
11.	SEQUENCES AND PROCEDURES, AND FOR COORDINATING THE VARIOUS PARTS OF THE WORK. THE CONTRACTOR IS RESPONSIBLE TO ENSURE THAT THERE IS NO DISRUPTION TO SERVICE, AND IF	10.	CONTRACTO
	DISRUPTION IS ANTICIPATED, TO NOTIFY THE DESIGN ENGINEER A MINIMUM OF 72 HOURS PRIOR, AND OBTAIN APPROVAL FOR THE DISRUPTION.	11.	ALL TRAFFIC FOR WORK O
12.	THE CONTRACTOR SHALL PROVIDE TEMPORARY UTILITY POLE SUPPORTS NECESSARY TO COMPLETE THE WORKS AS AN INCIDENTAL ITEM TO GENERAL CONTRACT REQUIREMENTS WHERE AND AS REQUIRED.	12.	APPROVAL O REQUIRED B
13.	CONTRACTOR TO MAINTAIN AN UP TO DATE SET OF AS-CONSTRUCTED DRAWINGS AT ALL TIMES. AS-CONSTRUCTED DRAWINGS TO BE DELIVERED TO THE ENGINEER AT SUBSTANTIAL PERFORMANCE FOR PREPARATION OF FINAL RECORD DRAWINGS. THE ENGINEER SHALL BE PROVIDED ACCESS TO REVIEW THE AS-CONSTRUCTED DRAWINGS AT ALL TIMES TO CONFIRM THEY ARE UP TO DATE.	13.	NOTICE OF C DETOUR ROL LOCATIONS.
14.	THE CONTRACTOR SHALL MAINTAIN AND MONITOR THE PROVISIONS FOR EROSION CONTROL AND SEDIMENT AS PER CONTRACT DOCUMENTS.	14.	THE CONTRA PERMANENT PERMANENT
15.	THE CONTRACTOR SHALL ADJUST ALL AFFECTED MANHOLE FRAME AND COVERS A MIN. 24 HOURS PRIOR TO FINAL TOP LIFT PAVING. ANY ADJUSTMENTS THAT DO NOT MEET MMCD TOLERANCES SHALL BE IMMEDIATELY RESET AND CORRECTED.		PAVING AND DAYS OF FINA PLACEMENT
16.	ALL PAVEMENT MARKINGS PAINT TO BE THERMOPLASTIC.	15.	THE CONTRA
17.	ALL TOP LIFT PAVING JOINTS TO BE LOCATED UNDER THE THERMOPLASTIC CENTERLINE PAVEMENT MARKINGS.	16.	THE CONTRA MOUNTAIN BI
18.	ALL ASPHALT JOINTS MUST BE SMOOTH AND WITHOUT VISIBLE BREAKS IN GRADE.		
19.	SUBMIT DENSITY TESTS TAKEN ON JOINTS. NO INDIVIDUAL TEST LESS THAN 95% DENSITY.		

20. ALL LANE DIMENSIONS ARE MEASURED TO THE CENTER OF LANE LINES (FOR DOUBLE LINE THE MEASUREMENT IS TO THE MIDDLE POINT BETWEEN THE 2 LINES).

PLOT DATE: N	/larch 4, 2025					
REV NO	REVISIONS	DATE	DRAWN	APPR'D		
А	70% SUBMISSION	2024-12-04	NL	KPT		
В	95% SUBMISSION	2025-01-28	NL	KPT	Cooutlam	
С	ISSUED FOR TENDER	2025-02-24	NL	KPT	Coçuitiani	
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## MANAGEMENT, NOTIFICATION AND APPROVALS NOTES:

ACTOR SHALL PROVIDE CONSTRUCTION SIGNAGE, BARRIERS, FLASHING INDICATORS, TIMES TO ENSURE THE SAFETY OF THE PUBLIC. TRAFFIC CONTROL WILL BE REQUIRED NSTRUCTION WORKS WITHIN THE TRAVELED PORTION OF THE ROAD. NO ROAD SHALL WITHOUT THE WRITTEN CONSENT OF THE DIRECTOR OF ENGINEERING AND

ACTOR SHALL BE RESPONSIBLE FOR THE DISPOSAL OF ALL EXCAVATED MATERIAL FOR REUSE AT A SUITABLE OFF-SITE DISPOSAL AREA, IN ACCORDANCE WITH ALL E REGULATIONS.

ACTOR SHALL ENSURE THAT ALL APPROVALS REQUIRED FOR THE PROPOSED WORKS OBTAINED FROM ALL AUTHORITIES AND AGENCIES PRIOR TO COMMENCING THE WORK.

ACTOR SHALL ARRANGE FOR, AND COORDINATE THE WORKS DONE BY:

COQUITLAM; AND

ISE UTILITIES (BC HYDRO, FORTIS GAS, BC TRANSMISSION CORP., SHAW CABLE, TELUS TRO VANCOUVER).

ACTOR SHALL CONTACT THE APPROPRIATE PERSONNEL AT LEAST 72 HOURS PRIOR TO SCHEDULING AND OTHER CONSTRUCTION CONSTRAINTS IMPOSED BY THESE WORKS AKEN INTO ACCOUNT.

DIRECTLY AFFECTED BY CONSTRUCTION OF THESE WORKS AND SERVICES SHALL BE YS WRITTEN NOTICE OF THE PROPOSED START OF CONSTRUCTION. THE CONTRACTOR IS UTE A NOTICE OF CONSTRUCTION LETTER TO ALL AFFECTED RESIDENTS AND S. FOLLOWING CONSTRUCTION ACTIVITY ON ANY PRIVATE PROPERTY, A WRITTEN AY BE REQUIRED FROM THE PROPERTY OWNER AT THE DISCRETION OF THE CITY.

AND PEDESTRIAN SAFETY CONTROL PLAN SHALL BE SUBMITTED BY THE CONTRACTOR HE PRE-CONSTRUCTION MEETING.

FOR REQUIRED TREE CUTTING OR TRIMMING NOT INDICATED IN CONTRACT DRAWINGS BTAINED BY THE CONTRACTOR FROM THE CITY PRIOR TO WORK BEING PERFORMED.

OR TO OBTAIN APPROVED LANE CLOSURE REQUEST FORM FOR ALL WORKS. APPROVED ARE CIRCULATED TO ALL EMERGENCY SERVICES.

OR TO SUBMIT A TRAFFIC MANAGEMENT PLAN WITH LANE CLOSURE REQUEST FOR ALL DS AND ANY LOCAL ROADS WHICH REQUIRE ANY DETOURS.

CONTROL TO CONFORM TO THE LATEST EDITION OF THE BC TRAFFIC CONTROL MANUAL ON ROADWAYS.

OF NOISE VARIANCE FOR ALL WORK OUTSIDE OF NORMAL APPROVED WORK HOURS BY THE CITY.

CONSTRUCTION SIGNS TO BE INSTALLED AT ALL PROJECT LIMITS AND PREFERRED UTE. NOTIFY CONTRACT ADMINISTRATOR WITH CONSTRUCTION SCHEDULE AND . SIGNS PROVIDED AND INSTALLED BY THE CONTRACTOR.

ACTOR WILL BE RESPONSIBLE FOR COMPLETION OF ALL TAPED TEMPORARY AND T PAINT AND THERMOPLASTIC PAVEMENT MARKINGS IN THE PLACE OF THE WORK. T LANE MARKINGS ARE TO BE PLACED WITHIN SEVENTY-TWO (72) HOURS OF FINAL PERMANENT THERMOPLASTIC PAVEMENT MARKINGS ARE TO BE PLACED WITHIN FIVE (5) VAL PAVING. ALL TEMPORARY MARKINGS TO BE REMOVED IMMEDIATELY FOLLOWING OF PERMANENT PAVEMENT MARKINGS.

ACTOR SHALL FAMILIARIZE HIMSELF WITH THE TRAFFIC MANAGEMENT DETAILED IONS IN THE CONTRACT DOCUMENTS.

ACTOR SHALL COORDINATE ANY TEMPORARY RELOCATION OF BUS STOPS WITH COAST BUS COMPANY.






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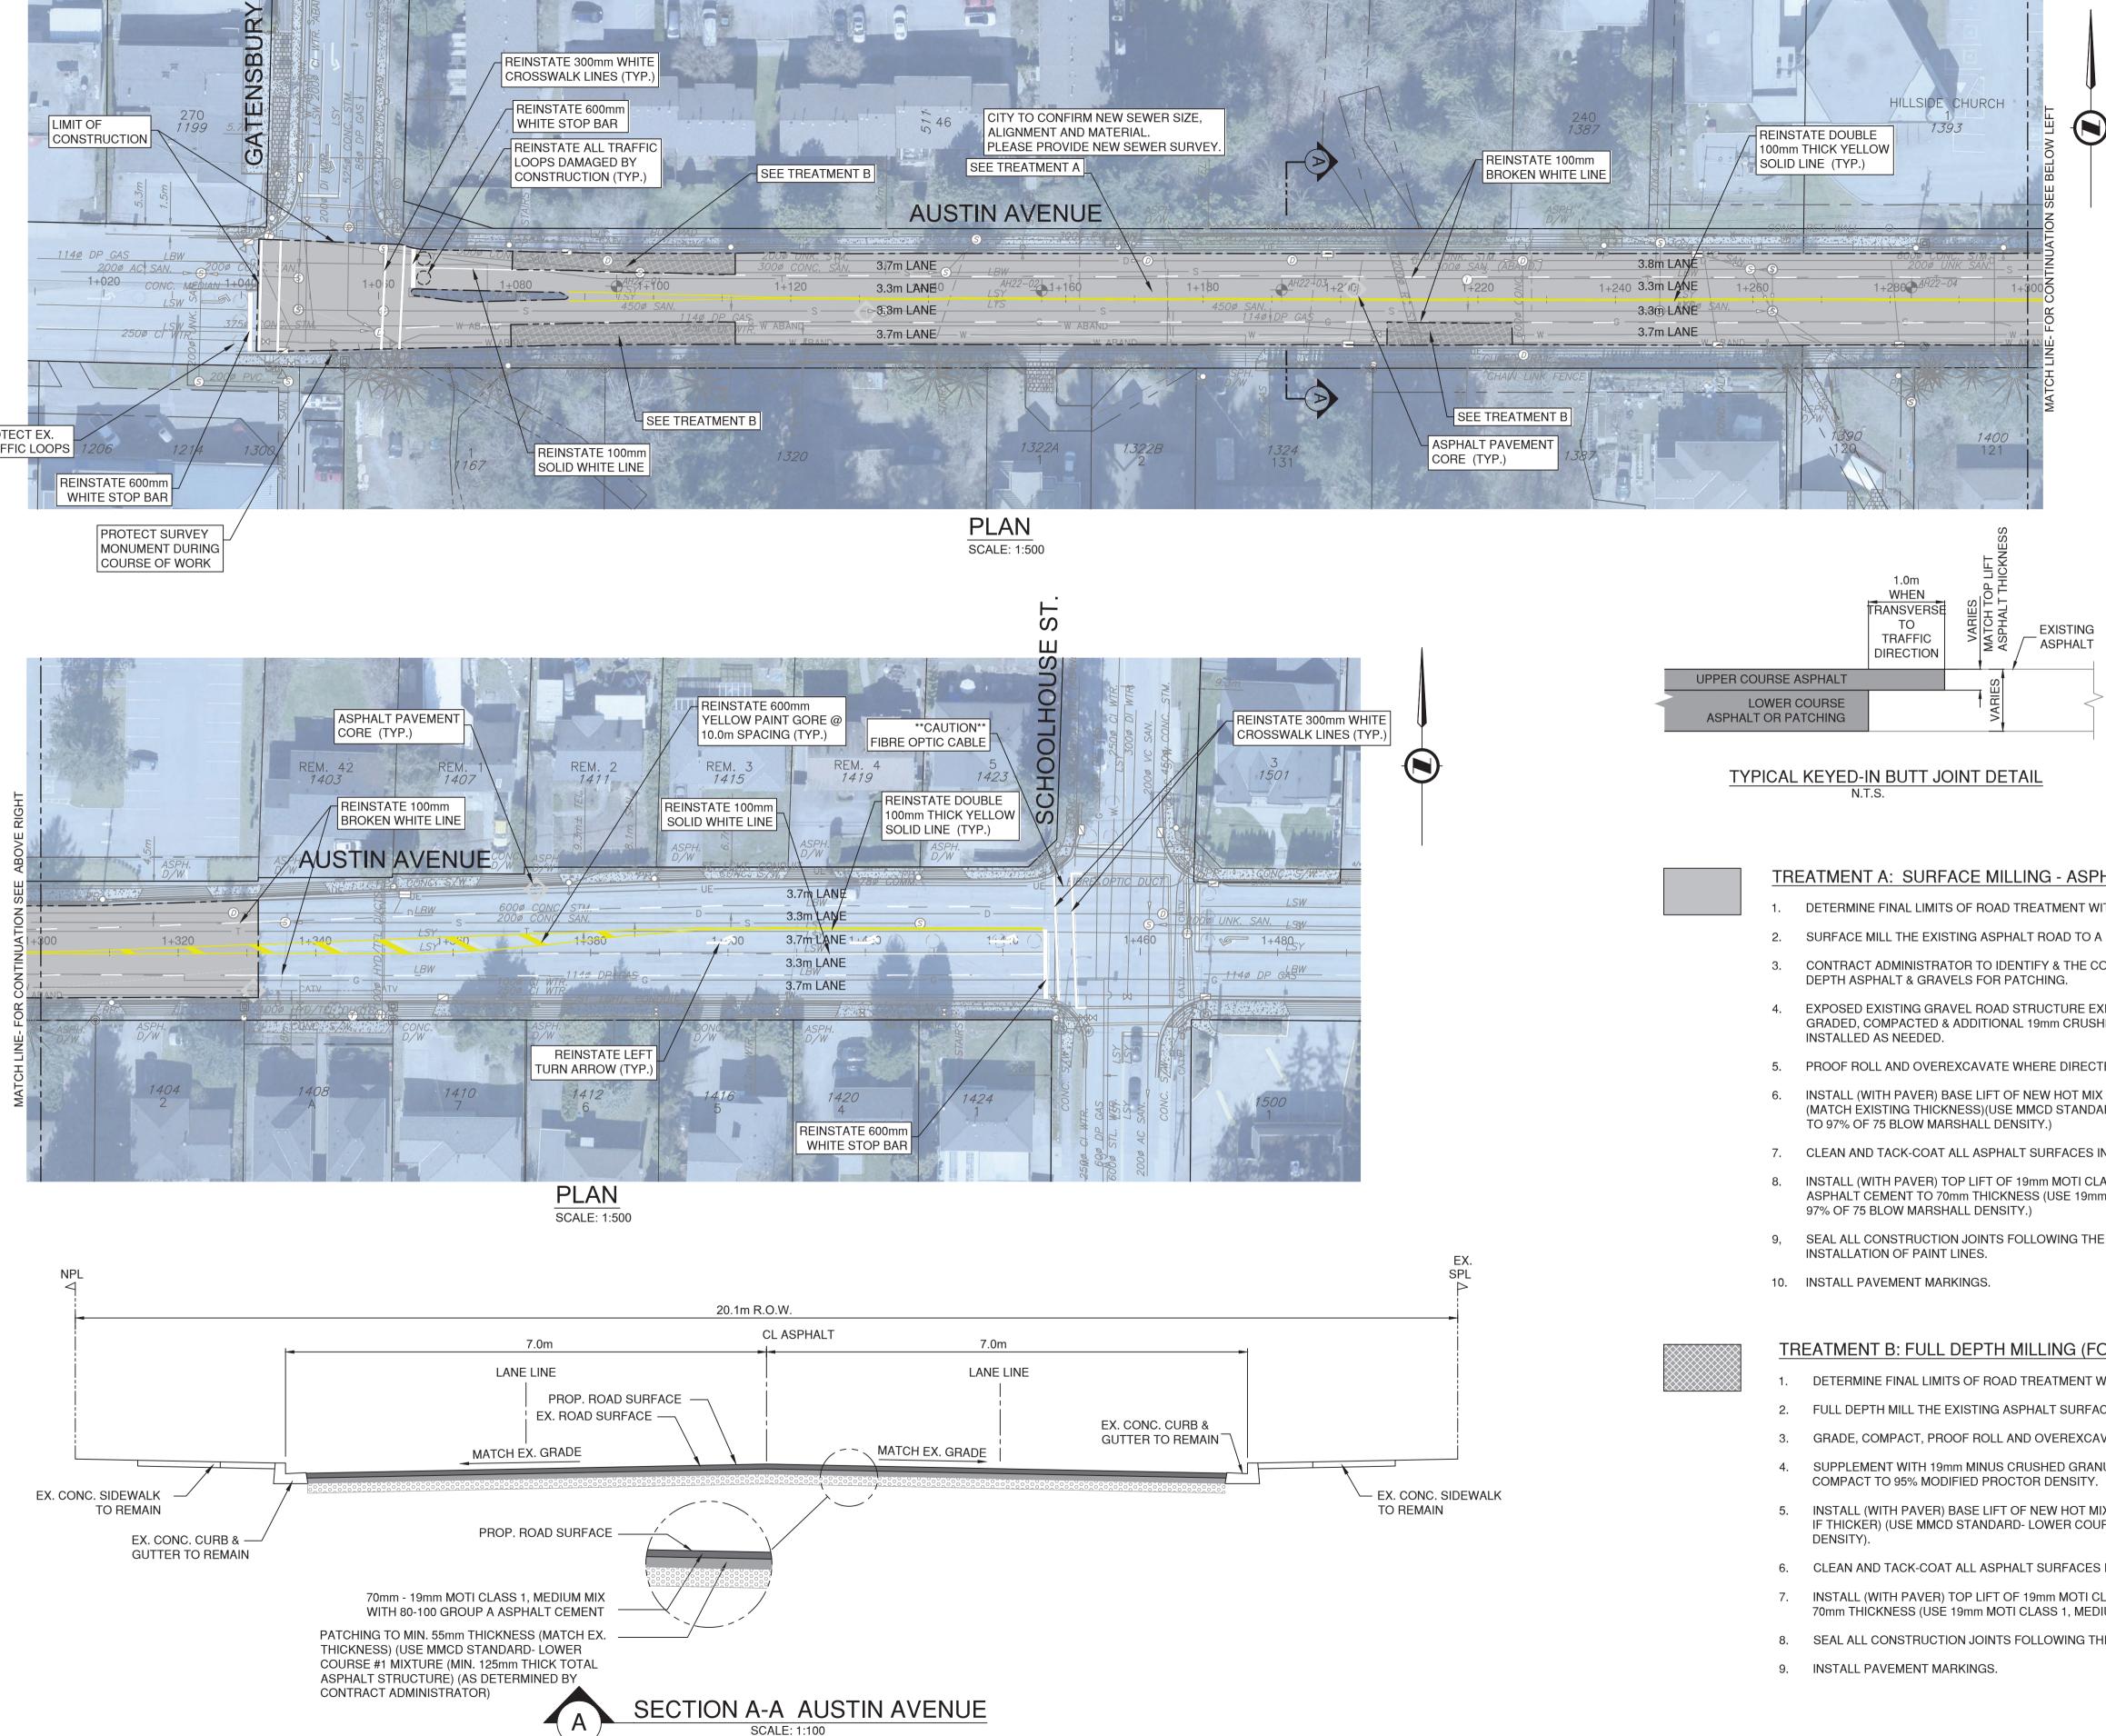
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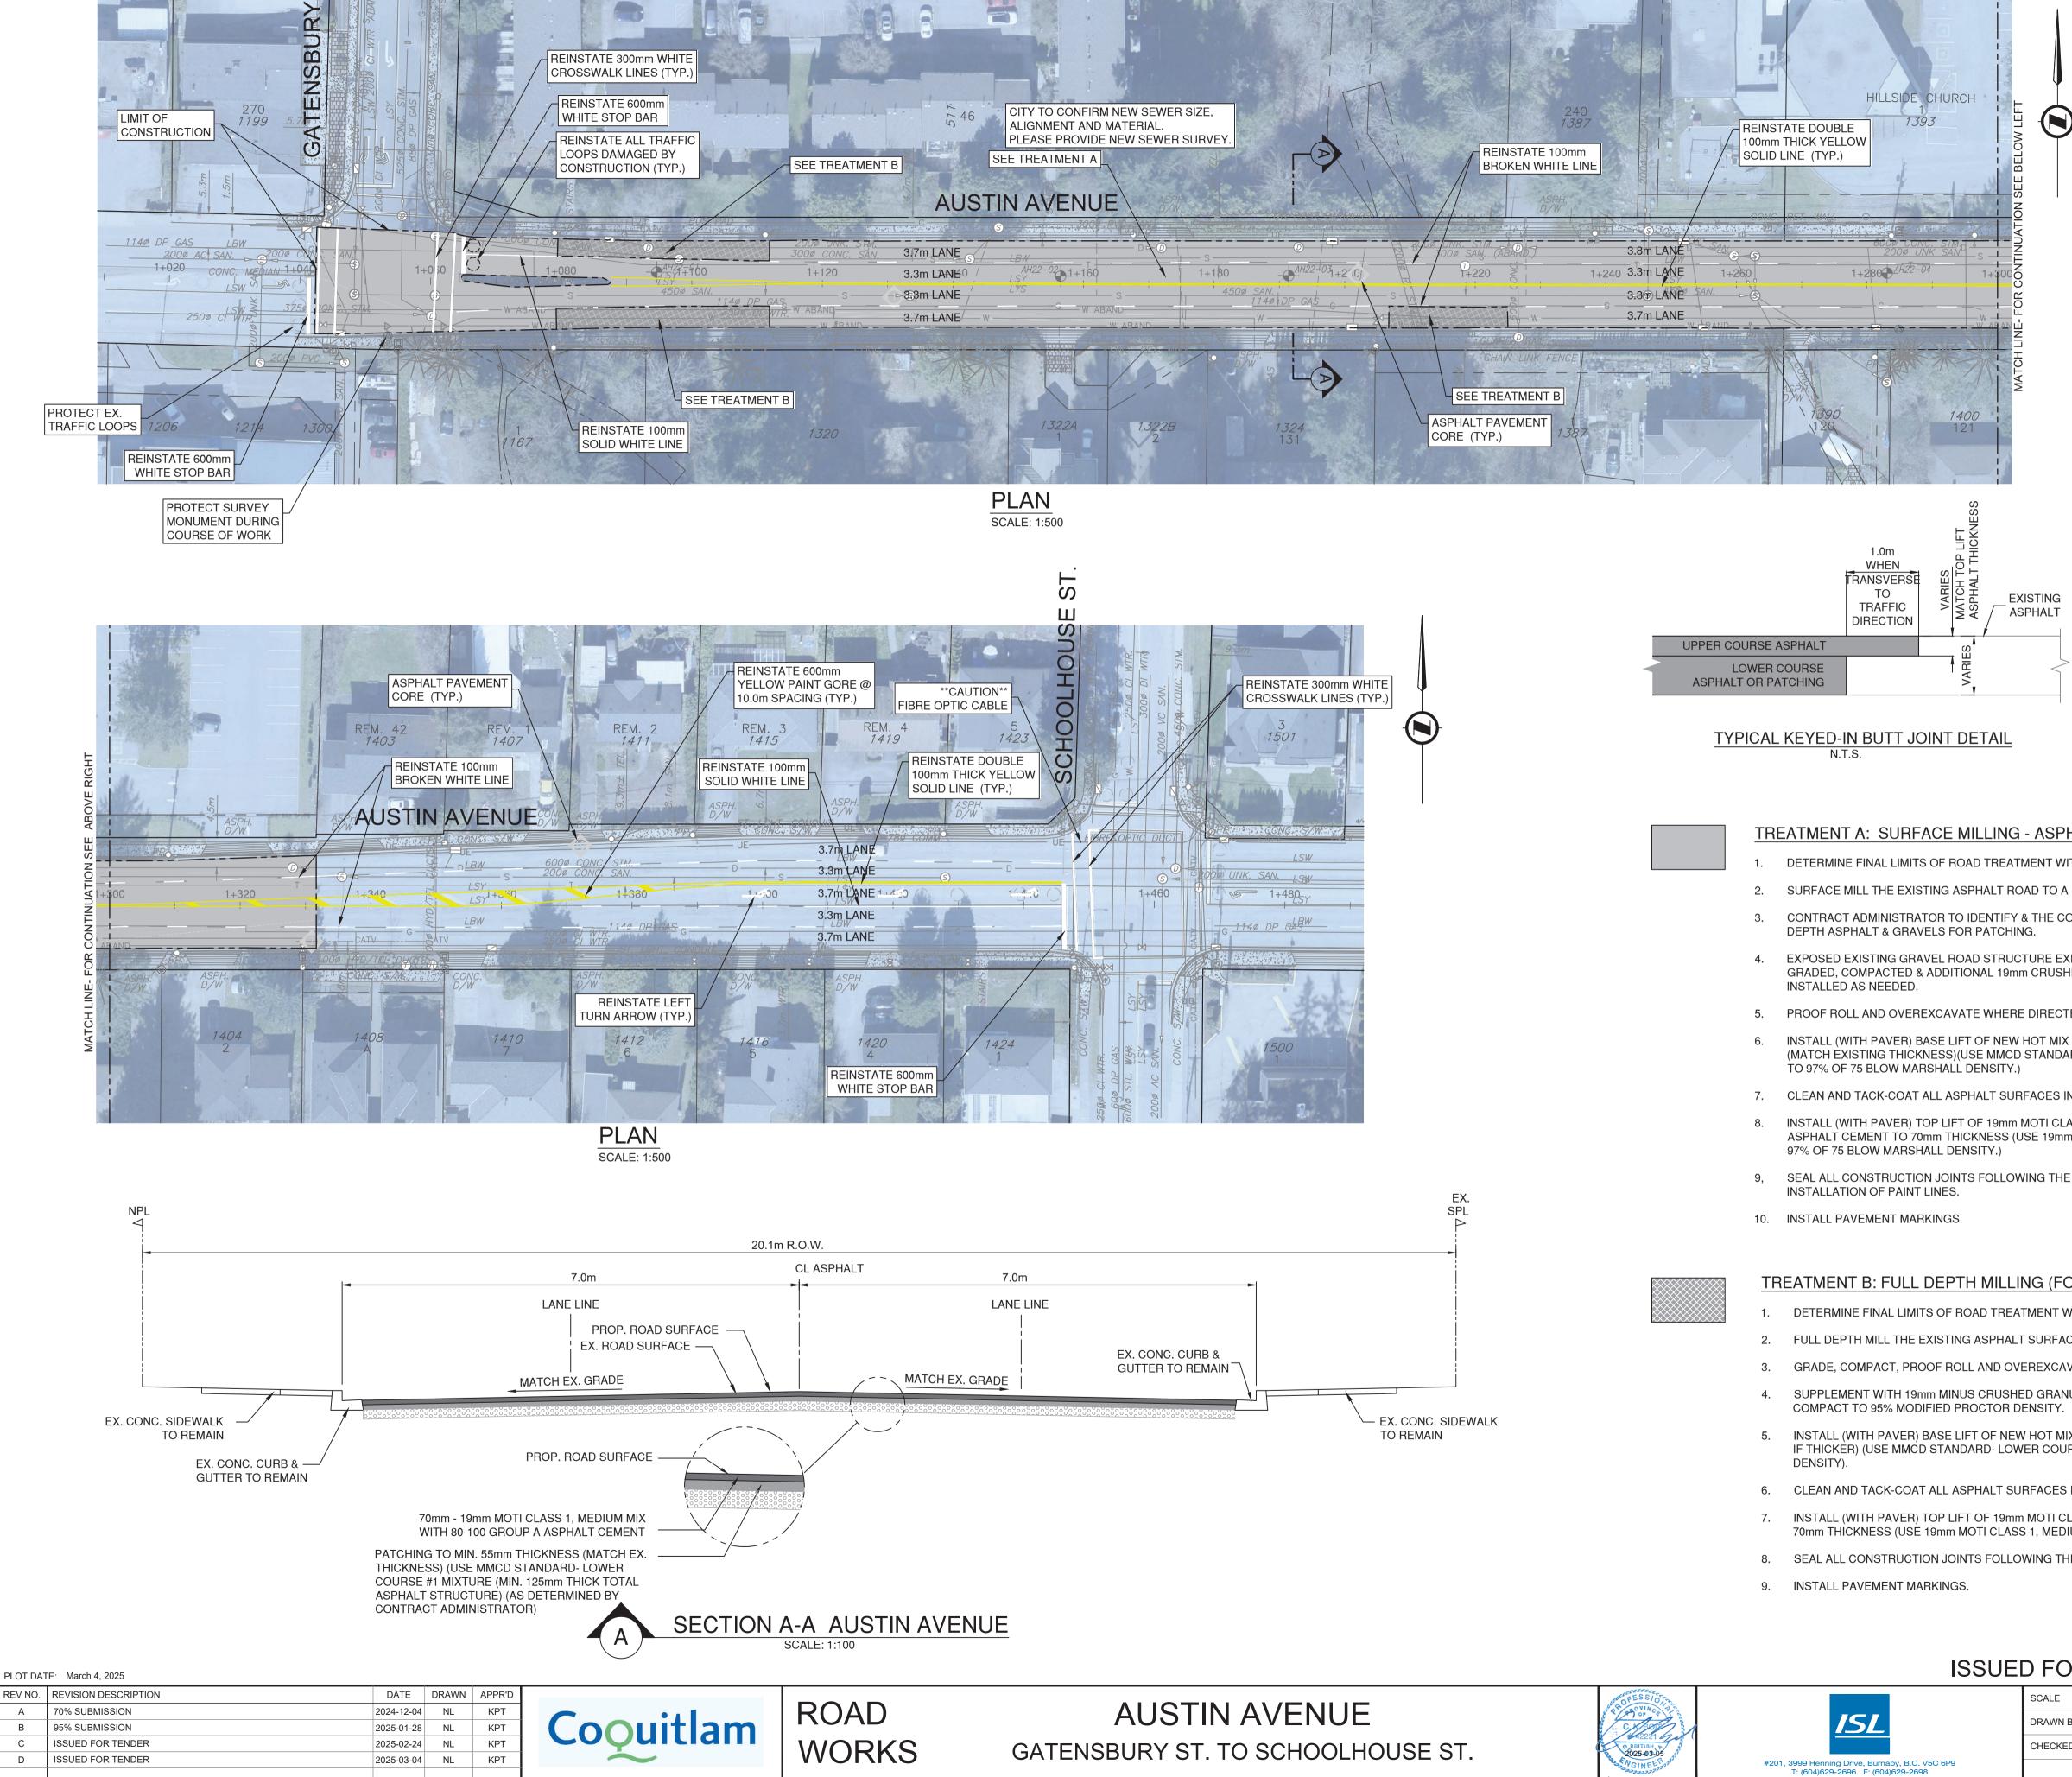
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### NOTE ADJUST MANHOLES, CATCH BASINS, LAWN BASINS, CLEANOUTS, VALVE COVERS, INSPECTION CHAMBERS, ETC. TO GRADE AS REQUIRED. REINSTATE ALL LOOPS CUT DURING SURFACE MILLING.

RECESSED RPM'S INSTALLED BY OTHERS

CORE	THICKNESS		
NO. 🖤	TOTAL	TOP	
1	130	50	
6	130	55	
7	130	55	
10	150	65	

CONTRACT ADMINISTRATOR TO IDENTIFY & THE CONTRACTOR SHALL REMOVE AREAS OF FULL

6. INSTALL (WITH PAVER) BASE LIFT OF NEW HOT MIX ASPHALT PATCHING TO MIN. 55mm THICKNESS (MATCH EXISTING THICKNESS)(USE MMCD STANDARD - LOWER COURSE #1 MIXTURE, COMPACTED

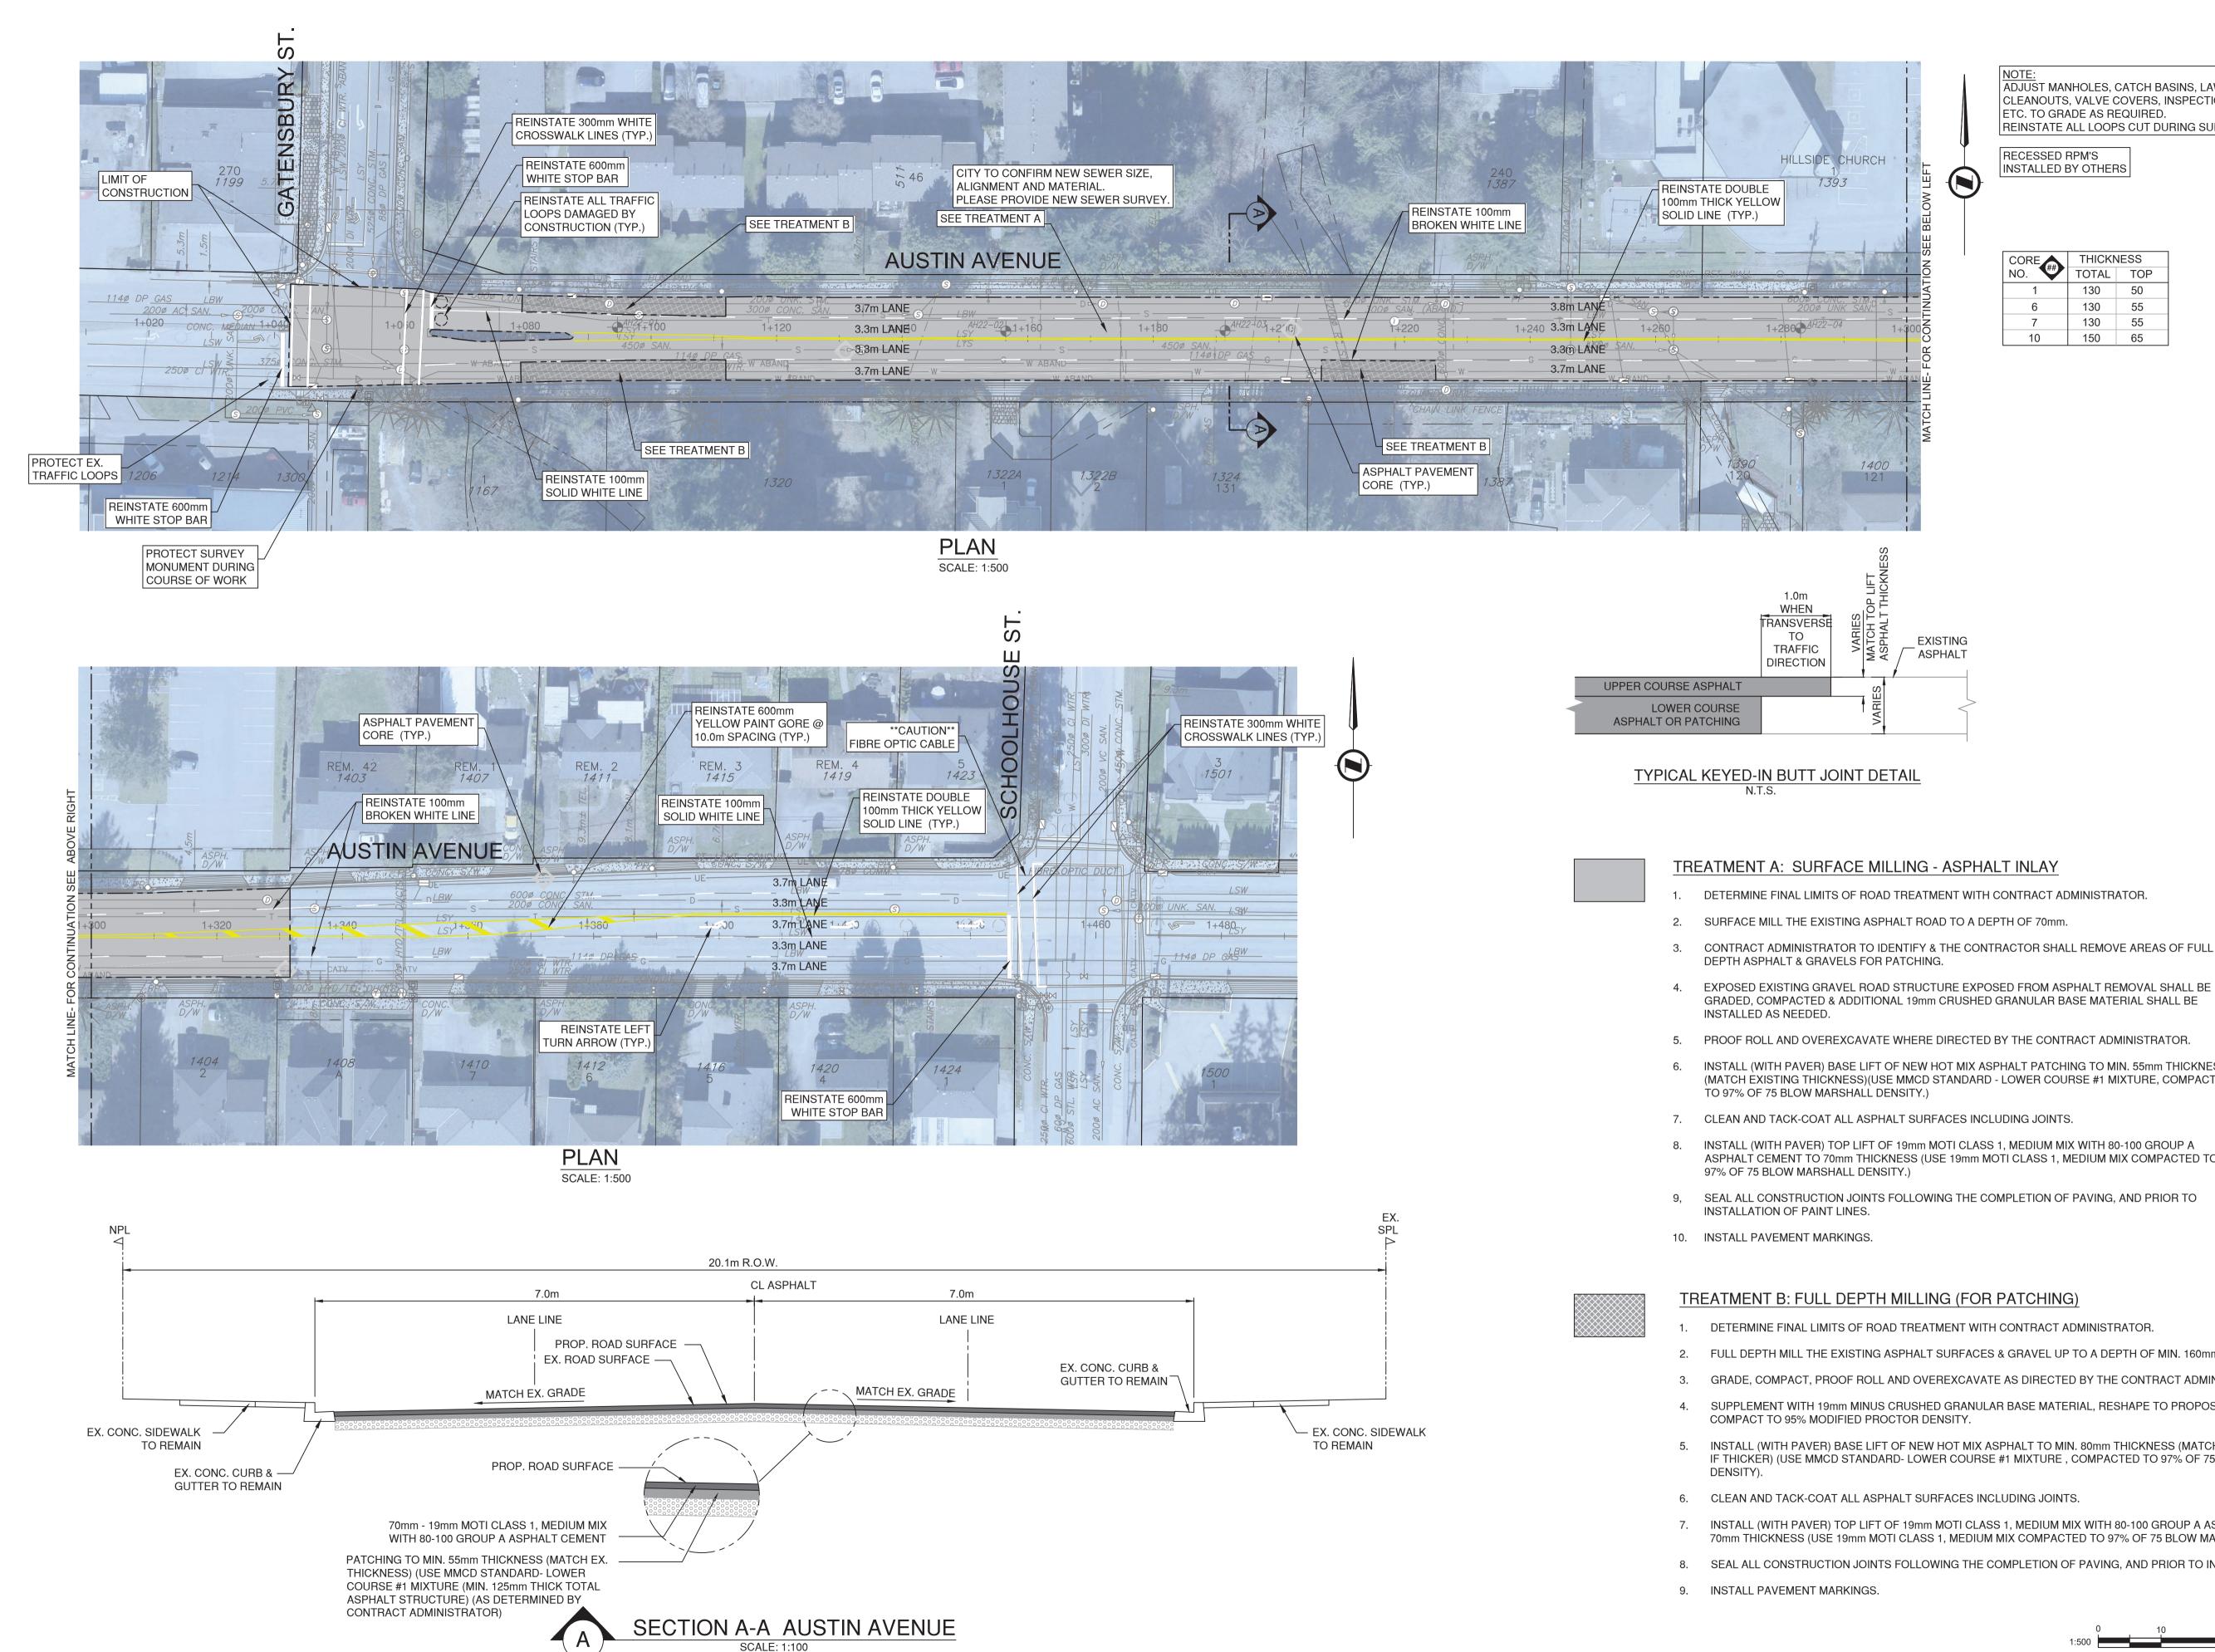ASPHALT CEMENT TO 70mm THICKNESS (USE 19mm MOTI CLASS 1, MEDIUM MIX COMPACTED TO

SEAL ALL CONSTRUCTION JOINTS FOLLOWING THE COMPLETION OF PAVING, AND PRIOR TO

2. FULL DEPTH MILL THE EXISTING ASPHALT SURFACES & GRAVEL UP TO A DEPTH OF MIN. 160mm.

3. GRADE, COMPACT, PROOF ROLL AND OVEREXCAVATE AS DIRECTED BY THE CONTRACT ADMINISTRATOR.


4. SUPPLEMENT WITH 19mm MINUS CRUSHED GRANULAR BASE MATERIAL, RESHAPE TO PROPOSED GRADES AND

5. INSTALL (WITH PAVER) BASE LIFT OF NEW HOT MIX ASPHALT TO MIN. 80mm THICKNESS (MATCH EXISTING THICKNESS IF THICKER) (USE MMCD STANDARD- LOWER COURSE #1 MIXTURE , COMPACTED TO 97% OF 75 BLOW MARSHALL

7. INSTALL (WITH PAVER) TOP LIFT OF 19mm MOTI CLASS 1, MEDIUM MIX WITH 80-100 GROUP A ASPHALT CEMENT TO 70mm THICKNESS (USE 19mm MOTI CLASS 1, MEDIUM MIX COMPACTED TO 97% OF 75 BLOW MARSHALL DENSITY.)

8. SEAL ALL CONSTRUCTION JOINTS FOLLOWING THE COMPLETION OF PAVING, AND PRIOR TO INSTALLATION OF PAINT LINES.

UEI	D FOR TEND	1:500 1:500 ER DESIGN NO.	30m	3408	34
	SCALE	1 : 500	CREATION DATE	2024-11-01	DWG. NO.
	DRAWN BY	NL	DESIGN BY	GL/RF	02 0F
	CHECKED BY	GL	APPROVED BY	KPT	03
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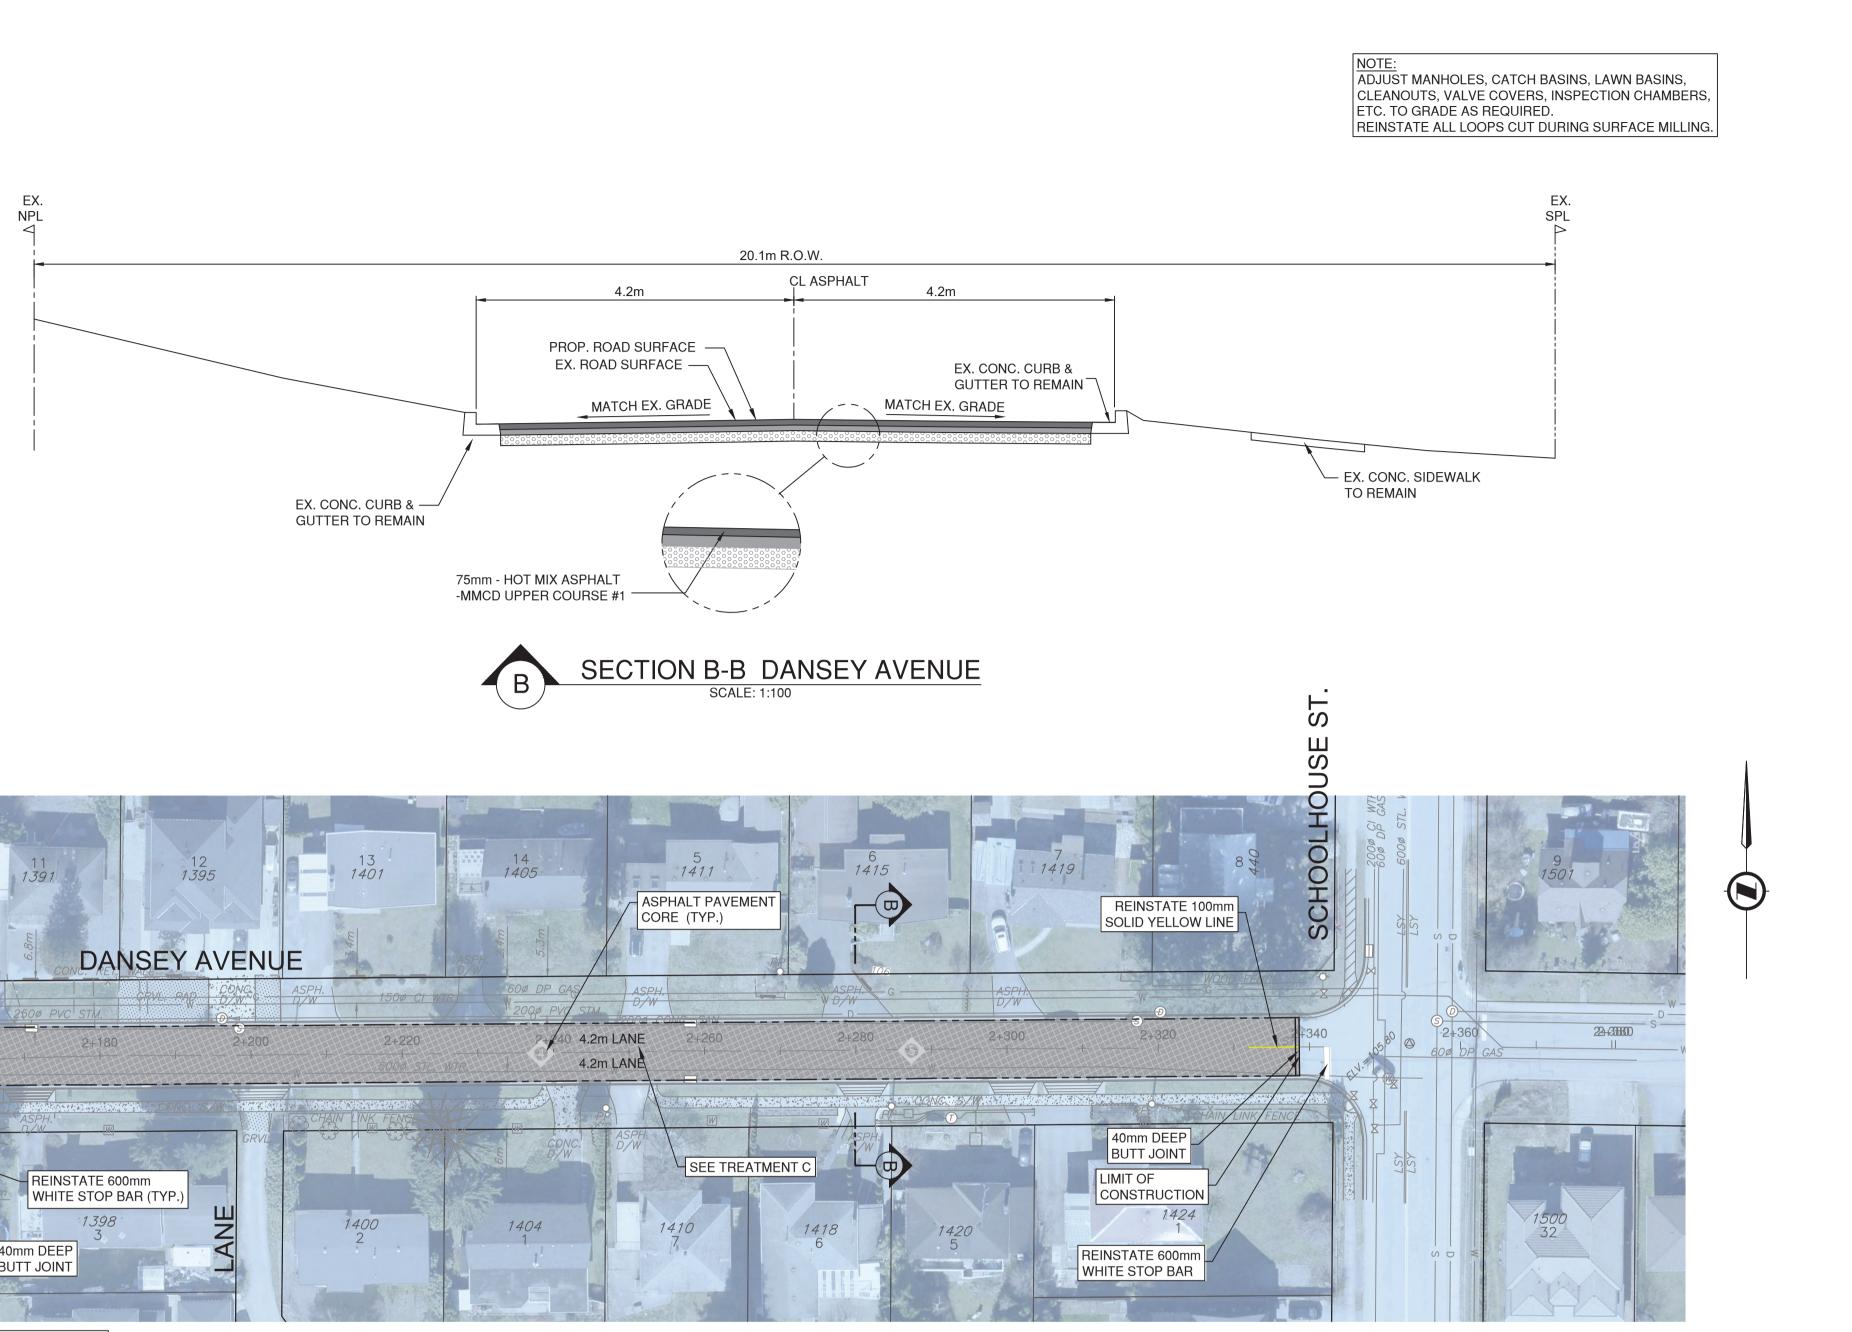


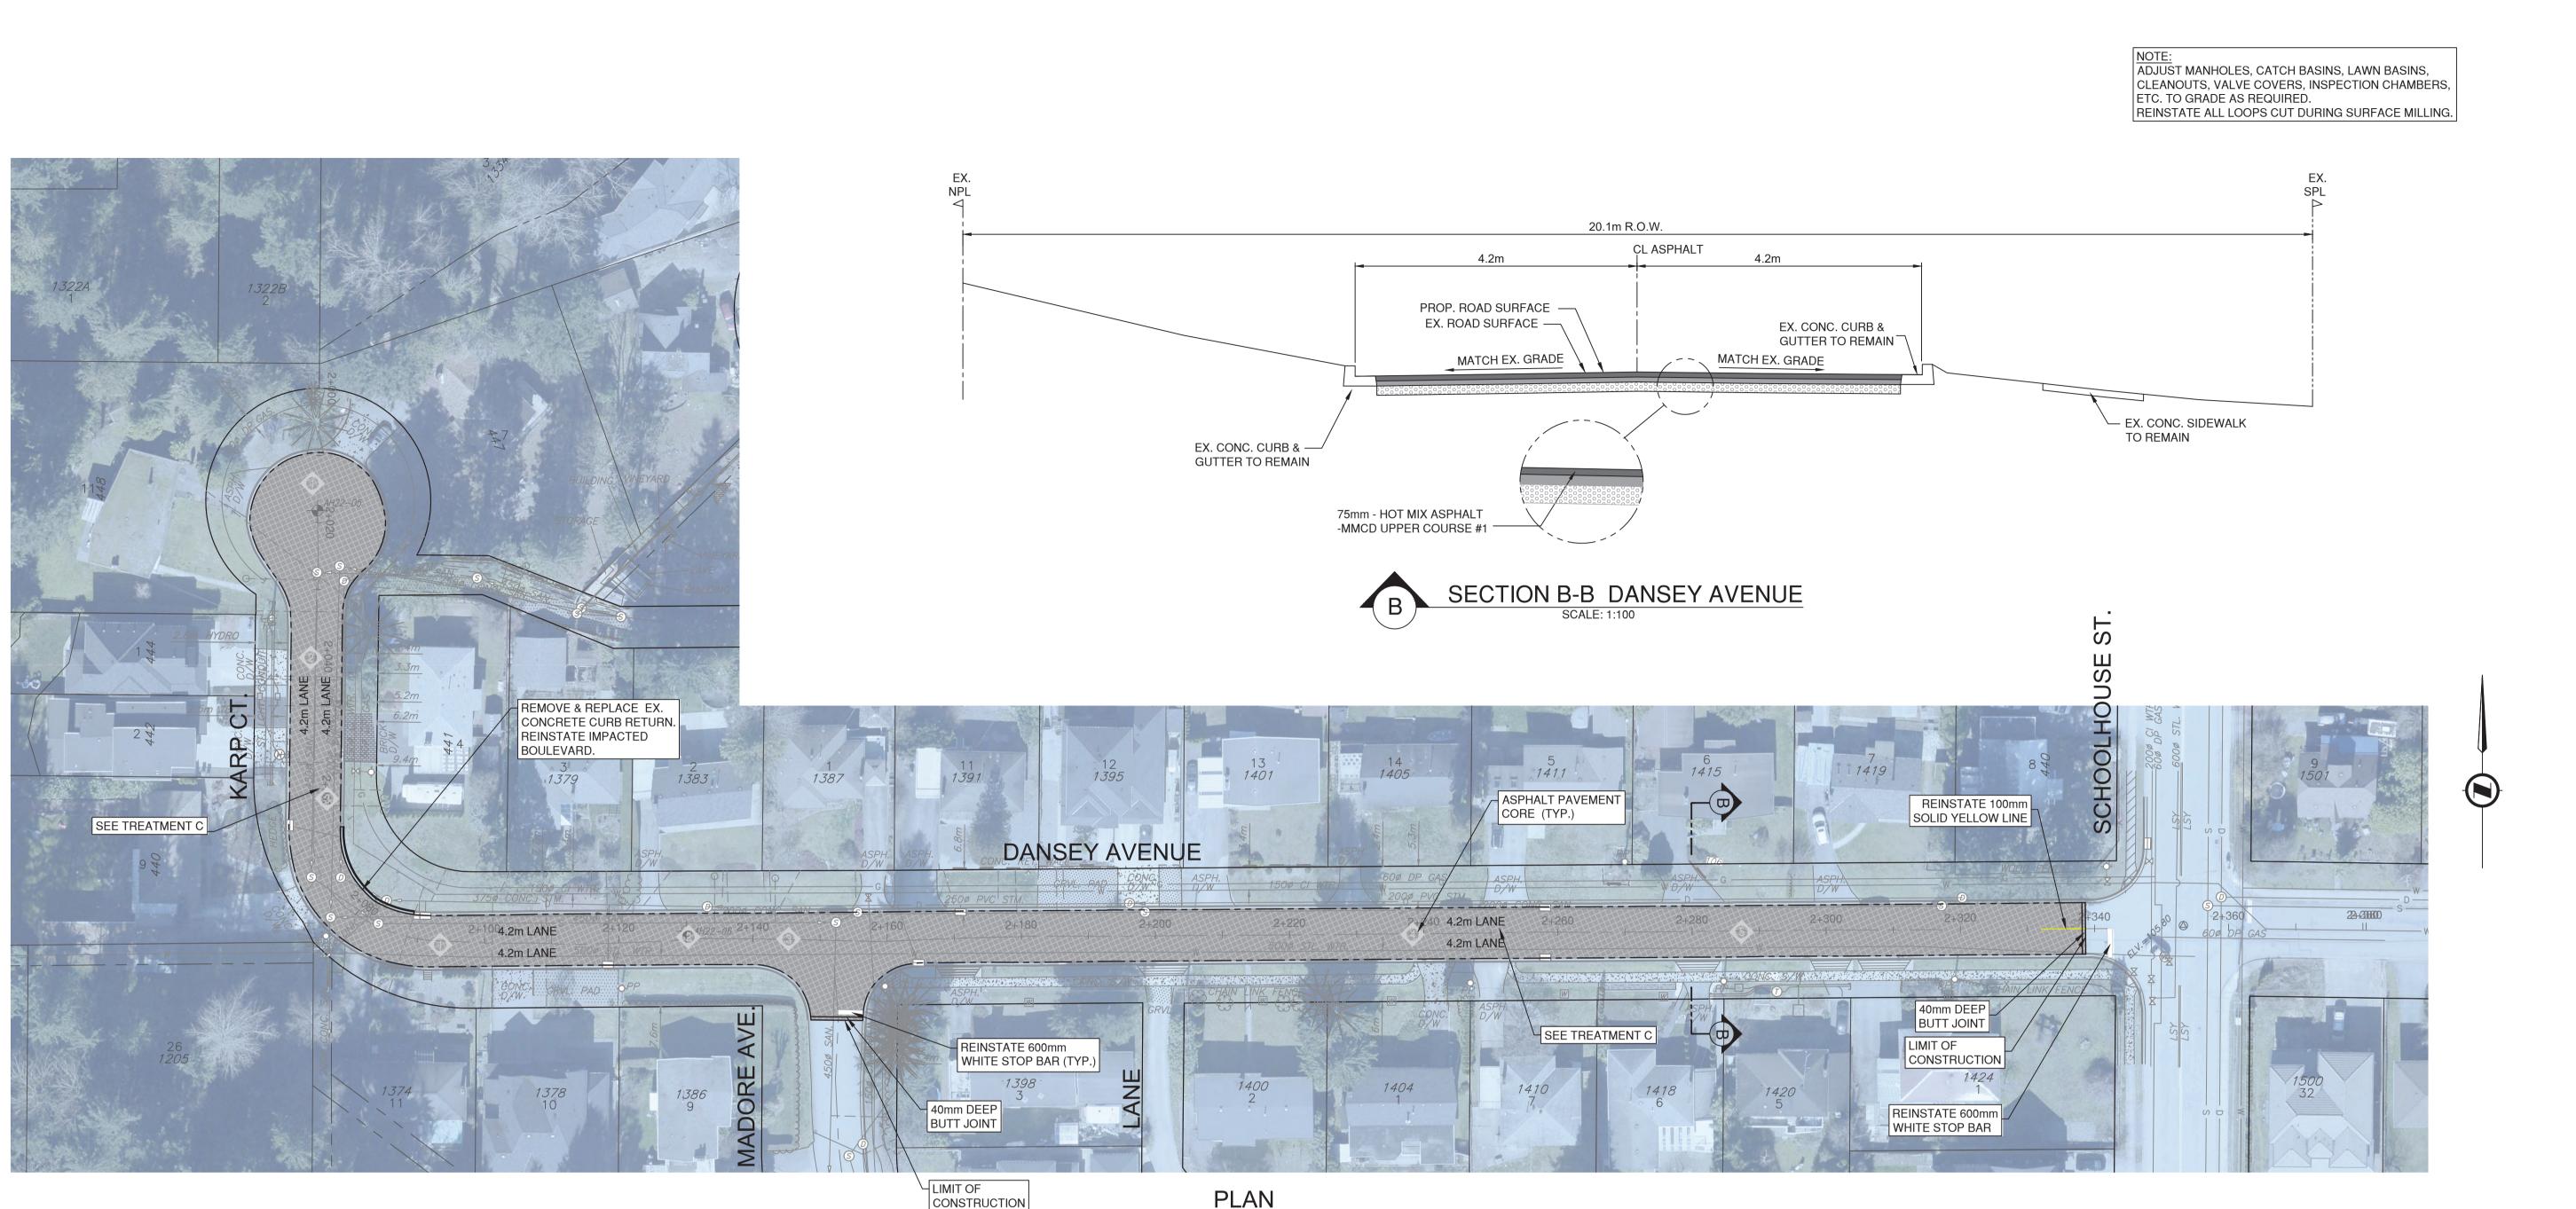KARP COURT				
CORE THICKNESS NO. TOTAL TOP				
TOTAL	TOP			
86	42			
100				
80	40			
	THICKN TOTAL 86 100			


DANSEY AVENUE					
CORE THICKNESS					
CORE	TOTAL TOP				
1	55	55			
2	70	70			
3	70	70			
4	65	65			
5	70	70			

PLOT	PLOT DATE: March 4, 2025				
REV	NO.	REVISION DESCRIPTION	DATE	DRAWN	APPR'D
A		70% SUBMISSION	2024-12-04	NL	KPT
В		95% SUBMISSION	2025-01-28	NL	KPT
С		ISSUED FOR TENDER	2025-02-24	NL	KPT

ROAD WORKS Coouitlam



PLAN SCALE: 1:500

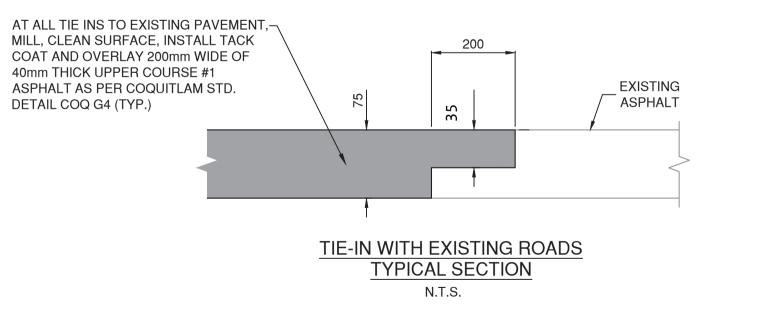


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# TREATMENT C: FULL DEPTH MILLING

- COMPACT TO 95% MODIFIED PROCTOR DENSITY.

- PAINT LINES.
- 8. INSTALL PAVEMENT MARKINGS.



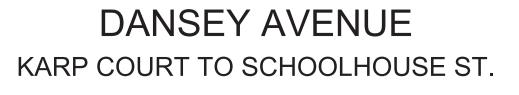



1. DETERMINE FINAL LIMITS OF ROAD TREATMENT WITH CONTRACT ADMINISTRATOR.

2. FULL DEPTH MILL THE EXISTING ASPHALT SURFACES & GRAVEL UP TO A DEPTH OF MIN. 100mm.

3. GRADE, COMPACT, PROOF ROLL AND OVEREXCAVATE AS DIRECTED BY THE CONTRACT ADMINISTRATOR.

4. SUPPLEMENT WITH 19mm MINUS CRUSHED GRANULAR BASE MATERIAL, RESHAPE TO PROPOSED GRADES AND

5. CLEAN AND TACK-COAT ALL ASPHALT SURFACES INCLUDING JOINTS.

6. INSTALL (WITH PAVER) TOP LIFT OF NEW HOT MIX ASPHALT TO 75mm THICK (USE MMCD STANDARD UPPER COURSE #1 MIXTURE, COMPACTED TO 97% OF 75 BLOW MARSHALL DENSITY.)

7. SEAL ALL CONSTRUCTION JOINTS FOLLOWING THE COMPLETION OF PAVING, AND PRIOR TO INSTALLATION OF

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	SCALE	1 : 500	CREATION DATE	2024-11-01	DWG. NO.
	DRAWN BY	NL	DESIGN BY	GL/RF	03 OF
	CHECKED BY	GL	APPROVED BY	KPT	03

rev. C