2025 PAVEMENT REHABILITATION Description:


LOUGHEED HIGHWAY

2111-06538-00 ML Project No:

73389 Client Project No:

ISSUED FOR TENDER



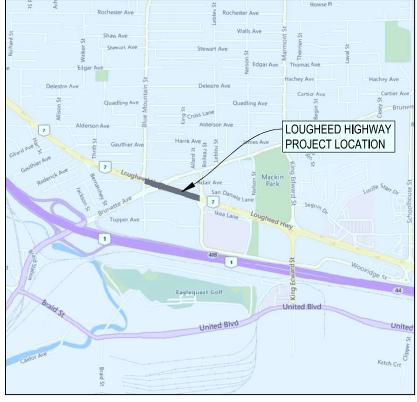



DRAWING INDEX					
SHEET NUMBER	SHEET TITLE				
00	COVER				
01	SITE PLAN - LOUGHEED HIGHWAY				
02	ROADWORKS - LOUGHEED HIGHWAY - STA, 0+998 TO STA, 1+100				
03	ROADWORKS - LOUGHEED HIGHWAY - STA. 1+100 TO STA. 1+229				
04	ROADWORKS - LOUGHEED HIGHWAY - STA. 1+229 TO STA. 1+318				
05	ROADWORKS - LOUGHEED & BRUNETTE INTERSECTION - TURNING MOVEMENTS				

73389



GENERAL CONSTRUCTION NOTES:

- GENERAL CONSTRUCTION NOTES:

 1. CONTACT & NOTIFY ALL HOMEOWNERS AFFECTED BY WORKS 4 WEEKS PRIOR TO CONSTRUCTION.

 2. ALL CONSTRUCTION AND MATERIALS SHALL CONFORM TO MUNICIPALITY STANDARD SPECIFICATIONS AND DRAWINGS UNLESS OTHERWISE NOTED ON THIS DRAWING.

 3. REPAIR AND/OR REPLACE ALL INFRASTRUCTURE/PRIVATE PROPERTY DAMAGED OR REMOVED DURING CONSTRUCTION, TO BETTER THAN, OR EQUAL TO PRE-CONSTRUCTION CONDITION,

 4. REINSTATE ALL PRIVATE PROPERTY AND BOULEVARDS TO PRE-CONSTRUCTION CONDITIONS.

 5. CONTACT MUNICIPALITY PARKS DEPARTMENT PRIOR TO WORKING IN AND AROUND TREES.

 6. ENSURE THE CURRENT MUNICIPAL O.H.&S. GROUND DISTURBANCE PRACTICE AND PROCEDURES ARE FOLLOWED, CONTACT BC1 AT 1-800-474-6898 FOR EXTERNAL UTILITY LOCATIONS AT LEAST 72 HOURS PRIOR TO THE STRAT OF CONSTRUCTION.

 7. NOTIFY THOSE HOMEOWNERS WHO WILL BE AFFECTED BY CONSTRUCTION 48 HAS BEFORE BEGINNING WORKS.

 8. CONFIRM LOCATION AND ELEVATION OF EXISTING UTILITIES AT ALL CROSSINGS AND CONNECTIONS PRIOR TO CONSTRUCTION.

- DURING CONSTRUCTION.

ENVIRONMENTAL NOTES:

USE BEST MANAGEMENT PRACTICES DURING CONSTRUCTION, ADJUST WORK ACTIVITIES DURING PERIODS OF HEAVY RAIN TO MINIMIZE SEDIMENTS ENTERING THE STORM DRAINAGE SYSTEM. SOME BMB'S TO CONSIDER:

- 1. CHECK ALL EQUIPMENT FOR FLUID LEAKS PRIOR TO ENTERING THE

- 1. CHECK ALL EQUIPMENT FOR FLUID LEAKS PRIOR TO ENTERING THE WORK AREA.
 2. NO EQUIPMENT RE-FUELING TO QCCUR IN THE WORK AREA UNLESS SPILL PROTECTION MEASURES ARE IN PLACE.
 3. A SPILL KT IS TO BE MAINTAINED ON SITE THROUGHOUT THE CONSTRUCTION PERIOD.
 4. SURFACE WATER IS TO BE MANAGED WITHIN THE WORK AREA AND TREATED BEFORE DISCHARGED. THIS MAY INCLUDE ONSITE DETENTION AND/OR CULVERT FILTHATION.
 5. COVER EXPOSED SOILS IN INCLEMENT WEATHER IS TARP, HYDRO SEED OR ORGANIO LEAF MULCH.
 6. STOCKPILE SOILS AWAY FROM CULVERT FILTETS AND ENSURE THEY ARE COVERED IF LEFT FOR MORE THAN 48 HOURS.
 7. SURROUND PROTECTED TREES WITH SNOW FENCING AT DRIP LINE OR CRITICAL ROOT ZONE OF TREE DURING CONSTRUCTION. CONTACT MUNICIPAL ARBORIST PRIOR TO BEGINNING CONSTRUCTION. INSTALL SILT FENCING AS PER DETAIL A IN LOCATION SHOWN ON PLAN.

ROADWORKS NOTES:

- ALL WORKS TO CONFORM TO THE MASTER MUNICIPAL
 CONSTRUCTION DOCUMENTS (2009 EDITION PLATINUM) AND ALL
 COQUITLAM APPROVED REVISIONS, AND TO THE CURRENT EDITION
 OF THE CITY OF COQUITLAM SUPPLEMENTAL SPECIFICATIONS AND
 STANDARD DETAIL DRAWINGS
- CHANGES OF GRADE AND DIRECTION FORMED BY SMOOTH VERTICAL AND HORIZONTAL CURVES.
- 3. ALL EXISTING MANHOLE FRAMES, WATER AND GAS VALVE BOXES, SURVEY MONUMENT BOXES ETC. TO BE ADJUSTED TO SUIT NEW PAVEMENT GRADE AND CROSS-FALL
- 4. CONTRACTOR TO VERIFY MINIMUM 2% CROSS-FALL PRIOR TO PAVING
- 5 CONTRACTOR IS RESPONSIBLE TO REPAIR ANY DAMAGE TO THE CURB, SIDEWALK, OR DRIVEWAYS DAMAGED BY THE MILLING OR PAVING OPERATION
- 6. RECESSED PAVEMENT MARKERS WILL BE INSTALLED BY OTHERS AFTER CONSTRUCTION.

SIGNAGE AND PAVEMENT MARKING NOTES:

- ALL PAVEMENT MARKINGS AND SIGNAGE AS PER THE MANUAL UNIFORM TRAFFIC CONTROL DEVICES FOR CANADA
- 2. ALL PAVEMENT MARKINGS ARE THERMOPLASTIC





SCALE 1:1000 SCALE

SHEET 01 OF 05 ENG PROJECT 2111-06538-00

2025 PAVEMENT REHABILITATION LOUGHEED HIGHWAY

DESCRIPTION SITE PLAN

BY REVISIONS

Coouitlam

DATE APRIL 11, 2025


DATE APR**I**L 11, 2025


DATE APRIL 11, 2025


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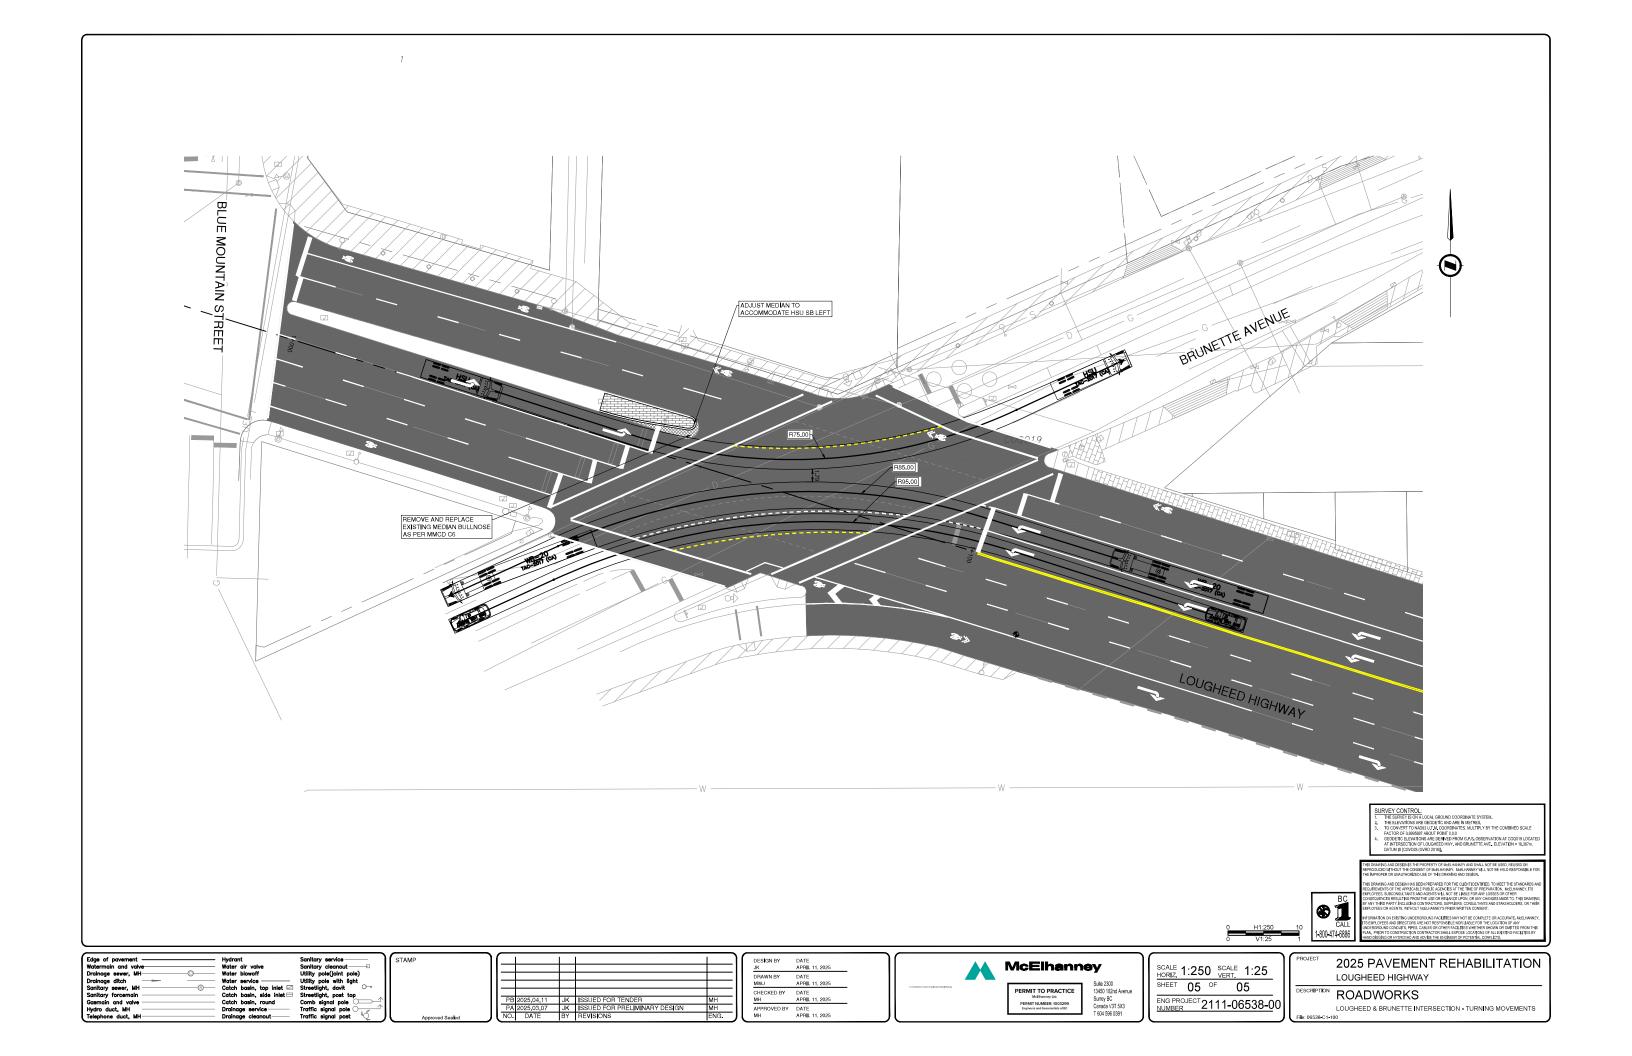
PERMIT TO PRACTICE

McElhanney



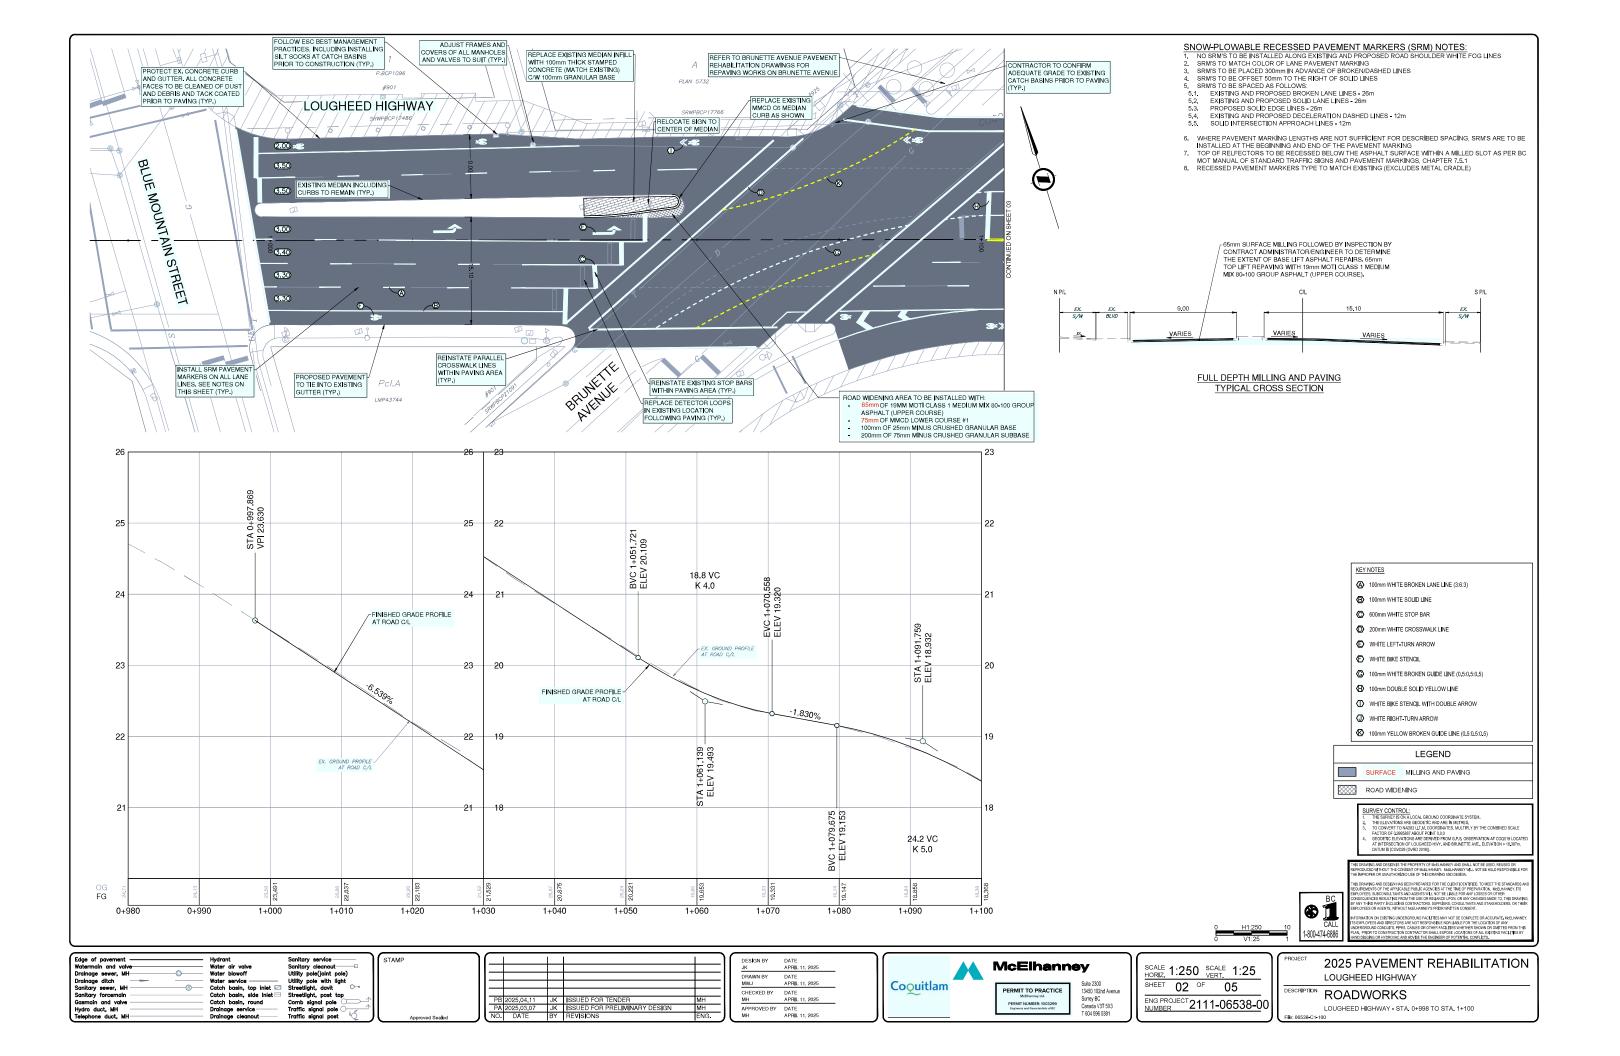

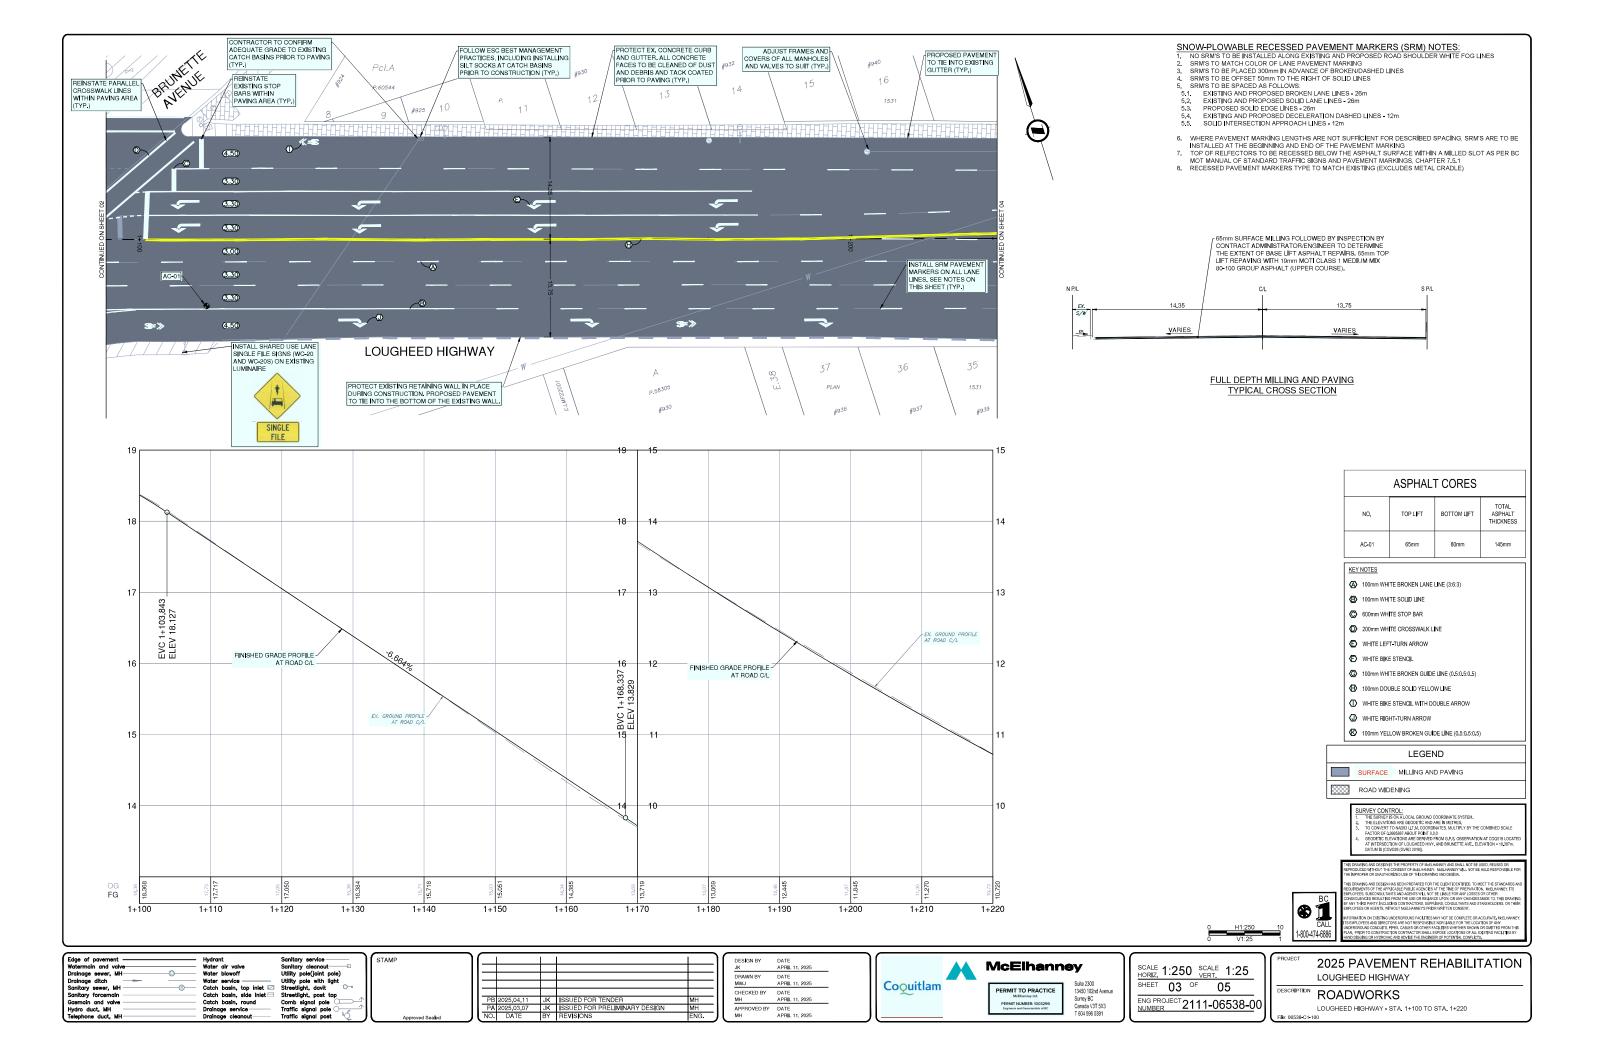

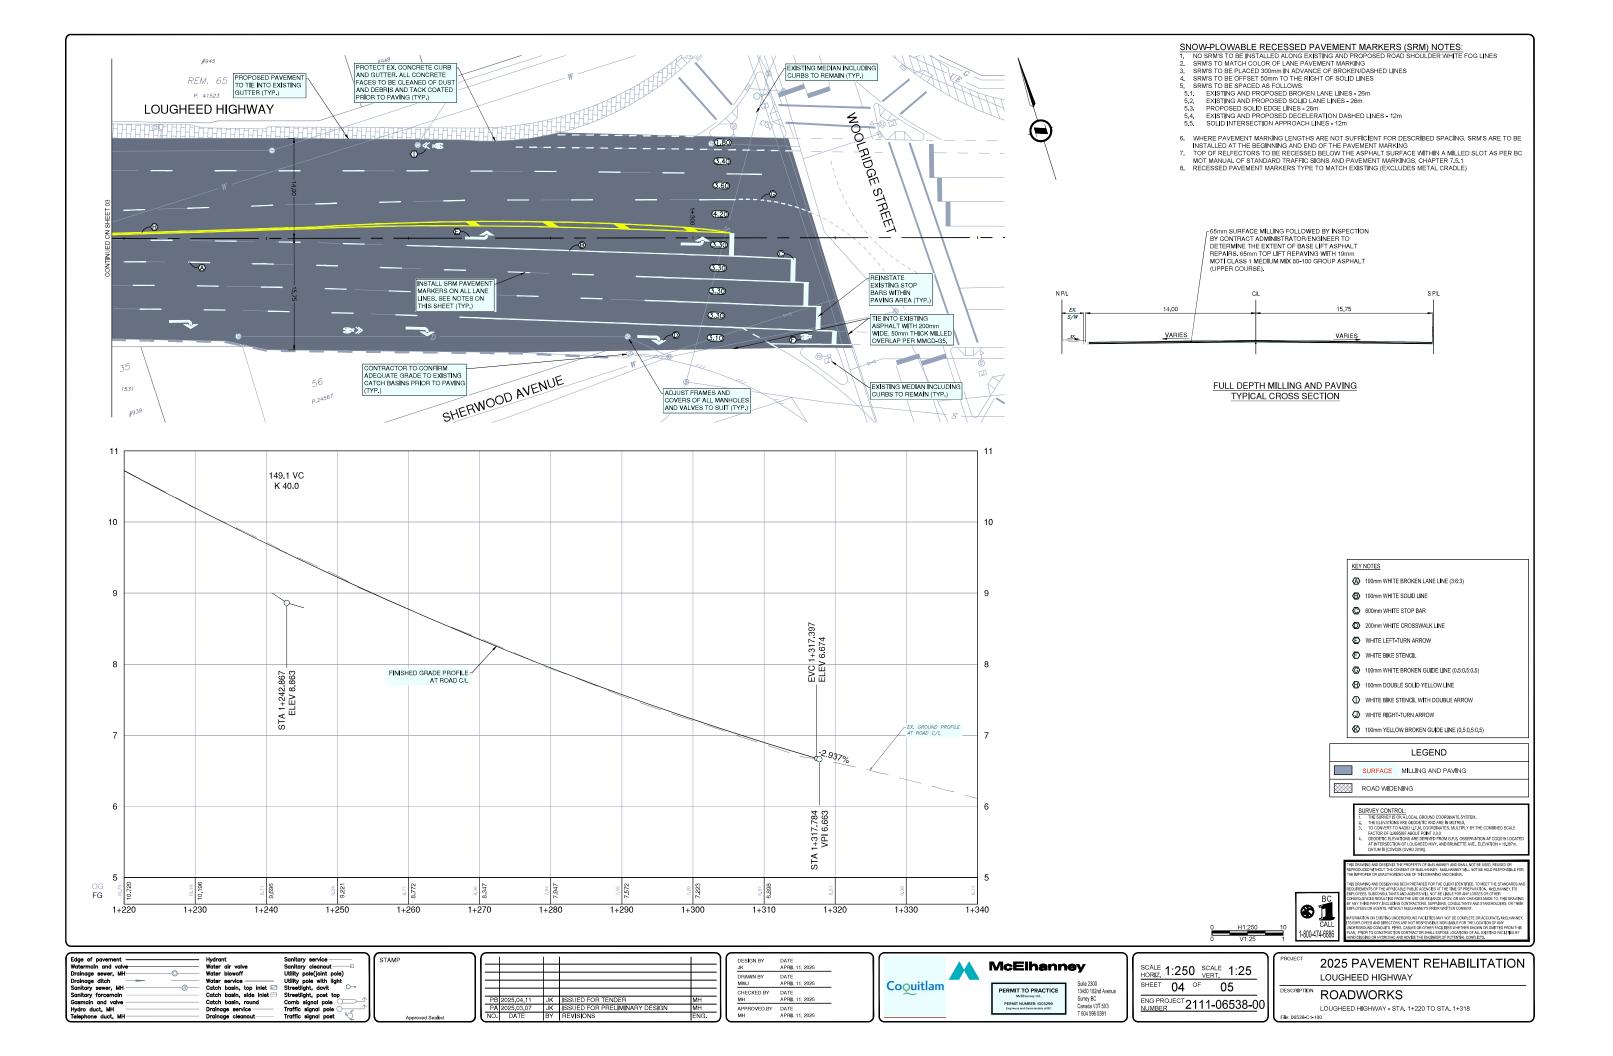

3000 GUILDFORD WAY, COQUITLAM


2025 PAVEMENT REHABILITATION Description:

BRUNETTE AVENUE

2111-06538-00 ML Project No:

73389 Client Project No:

ISSUED FOR TENDER

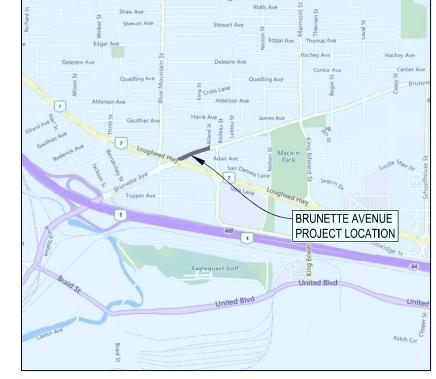



	DRAWING INDEX
SHEET NUMBER	SHEET TITLE
00	COVER
01	SITE PLAN - BRUNETTE AVENUE
02	ROADWORKS - BRUNETTE AVENUE - STA. 0+988 TO STA. 1+113
03	ROADWORKS - BRUNETTE AVENUE - STA, 1+113 TO STA, 1+227



McElhanney

Suite 2300 13450 102nd Avenue Surrey BC Canada V3T 5X3 T 604 596 0391



GENERAL CONSTRUCTION NOTES:

- 1. CONTACT & NOTIFY ALL HOMEOWNERS AFFECTED BY WORKS 4 WEEKS
- CONTACT & NOTIFY ALL HOMEOWNERS AFFECTED BY WORKS 4 WEEKS PRIOR TO CONSTRUCTION.

 ALL CONSTRUCTION AND MATERIALS SHALL CONFORM TO MUNICIPALITY STANDARD SPECIFICATIONS AND DRAWINGS UNLESS OTHERWISE NOTED ON THIS DRAWING.

 BEPAIR AND/OR REPLACE ALL INFRASTRUCTURE/PRIVATE PROPERTY DAMAGED OR REMOVED DURING CONSTRUCTION, TO BETTER THAN, OR EQUAL TO PRE-CONSTRUCTION CONDITION.

 REINSTATE ALL PRIVATE PROPERTY AND BOULEVARDS TO PRE-CONSTRUCTION CONDITIONS.
- PRE-CONSTRUCTION CONDITIONS.
 5. CONTACT MUNICIPALITY PARKS DEPARTMENT PRIOR TO WORKING IN
- CON IAC I MUNICIPALITY PARKS DEPART IMENT PHION TO WORKING IN AND AROUND TREES.
 ENSURE THE CURRENT MUNICIPAL O.H.&S. GROUND DISTURBANCE PRACTICE AND PROCEDURES ARE FOLLOWED. CONTACT BC1 AT 1-800-474-6886 FOR EXTERNAL UTILITY LOCATIONS AT LEAST 72 HOURS PRIOR TO THE START OF CONSTRUCTION.
 NOTIFY THOSE HOMEOWNERS WHO WILL BE AFFECTED BY CONSTRUCTION.

- CONSTRUCTION 49 HRS BEFORE BEGINNING WORKS.

 CONFIRM LOCATION AND ELEVATION OF EXISTING UTILITIES AT ALL CROSSINGS AND CONNECTIONS PRIOR TO CONSTRUCTION.

 ENSURE ALL EXISTING SERVICES STAY IN OPERATIONAL CONDITION DURING CONSTRUCTION.

ENVIRONMENTAL NOTES:

USE BEST MANAGEMENT PRACTICES DURING CONSTRUCTION. ADJUST WORK ACTIVITIES DURING PERIODS OF HEAVY RAIN TO MINIMIZE SEDIMENTS ENTERING THE STORM DRAINAGE SYSTEM. SOME BMB'S TO

- CONSIDER:

 1. CHECK ALL EQUIPMENT FOR FLUID LEAKS PRIOR TO ENTERING THE WORK AREA.

 2. NO EQUIPMENT RE-FUELING TO OCCUR IN THE WORK AREA UNLESS SPILL PROTECTION MEASURES ARE IN PLACE.

 3. A SPILL KIT IS TO BE MAINTAINED ON SITE THROUGHOUT THE CONSTRUCTION PERIOD

 4. SURFACE WATER IS TO BE MANAGED WITHIN THE WORK AREA AND TREATED BEFORE DISCHARGED, THIS MAY INCLUDE ONSITE DETENTION AND/OR CULVERT FILITATION.

 5. COVER EXPOSED SOLES IN INCLEMENT WEATHER IS TANP, HYDRO SEED OR ORGANIC LEAF MULCH

 6. STOCKPILE SOLIS AWAY FROM CULVERT INLETS AND ENSURE THEY ARE COVERED IF LEFT FOR MORE THAN 48 HOURS.

 7. SURROUND PROTECTED TREES WITH SNOW FENCING AT DRIP LINE OR CRITICAL ROOT ZORE OF TREED URINING CONSTRUCTION, ONTACT MUNICIPAL ARBORIST PRIOR TO BEGINNING CONSTRUCTION, INSTALL SILT FENCING AS PER DETAIL A IN LOCATION SHOWN ON PLAN.

ROADWORKS NOTES:

- 1. ALL WORKS TO CONFORM TO THE MASTER MUNICIPAL CONSTRUCTION DOCUMENTS (2009 EDITION - PLATINUM) AND ALL COQUITLAM APPROVED REVISIONS, AND TO THE CURRENT EDITION OF THE CITY OF COQUITLAM SUPPLEMENTAL SPECIFICATIONS AND STANDARD DETAIL DRAWINGS
- CHANGES OF GRADE AND DIRECTION FORMED BY SMOOTH VERTICAL AND HORIZONTAL CURVES.
- 3. ALL EXISTING MANHOLE FRAMES, WATER AND GAS VALVE BOXES, SURVEY MONUMENT BOXES ETC. TO BE ADJUSTED TO SUIT NEW PAVEMENT GRADE AND CROSS-FALL
- 4. CONTRACTOR TO VERIFY MINIMUM 2% CROSS-FALL PRIOR TO PAVING
- 5. CONTRACTOR IS RESPONSIBLE TO REPAIR ANY DAMAGE TO THE CURB, SIDEWALK, OR DRIVEWAYS DAMAGED BY THE MILLING OR PAVING OPERATION
- 6. RECESSED PAVEMENT MARKERS WILL BE INSTALLED BY OTHERS AFTER CONSTRUCTION

SIGNAGE AND PAVEMENT MARKING NOTES:

- ALL PAVEMENT MARKINGS AND SIGNAGE AS PER THE MANUAL UNIFORM TRAFFIC CONTROL DEVICES FOR CANADA
- 2. ALL PAVEMENT MARKINGS ARE THERMOPLASTIC





Edward annual	
Edge of pavement ———— Watermain and valve	
Drainage sewer, MH	
Drainage ditch	
Sanitary sewer, MH	
Sanitary forcemain —	
Gasmain and valve ———	
Hydro duct MH	

TAMP			I .	1	ı
	PB	2025.04.11	JK	ISSUED FOR TENDER	MH
	PA	2025.03.07	JK	ISSUED FOR PRELIMINARY DESIGN	MH
Approved Sealed	NO.	DATE	BY	REVISIONS	ENG.
	_	DESTROY ALL DOM	TO DEA	DINC DDD/IOUR DEVIRION	

JK	APR I L 11, 2025
DRAWN BY	DATE
MWJ	APRIL 11, 2025
CHECKED BY	DATE
MH	APRIL 11, 2025
APPROVED BY	DATE ADRII 11 2025







13450 102nd Avenue Surrey BC Canada V3T 5X3 T 604 596 0391 PERMIT TO PRACTICE

SCALE 1:1000 SCALE SHEET 01 OF 03 ENG PROJECT 2111-06538-00 2025 PAVEMENT REHABILITATION BRUNETTE AVENUE

DESCRIPTION SITE PLAN

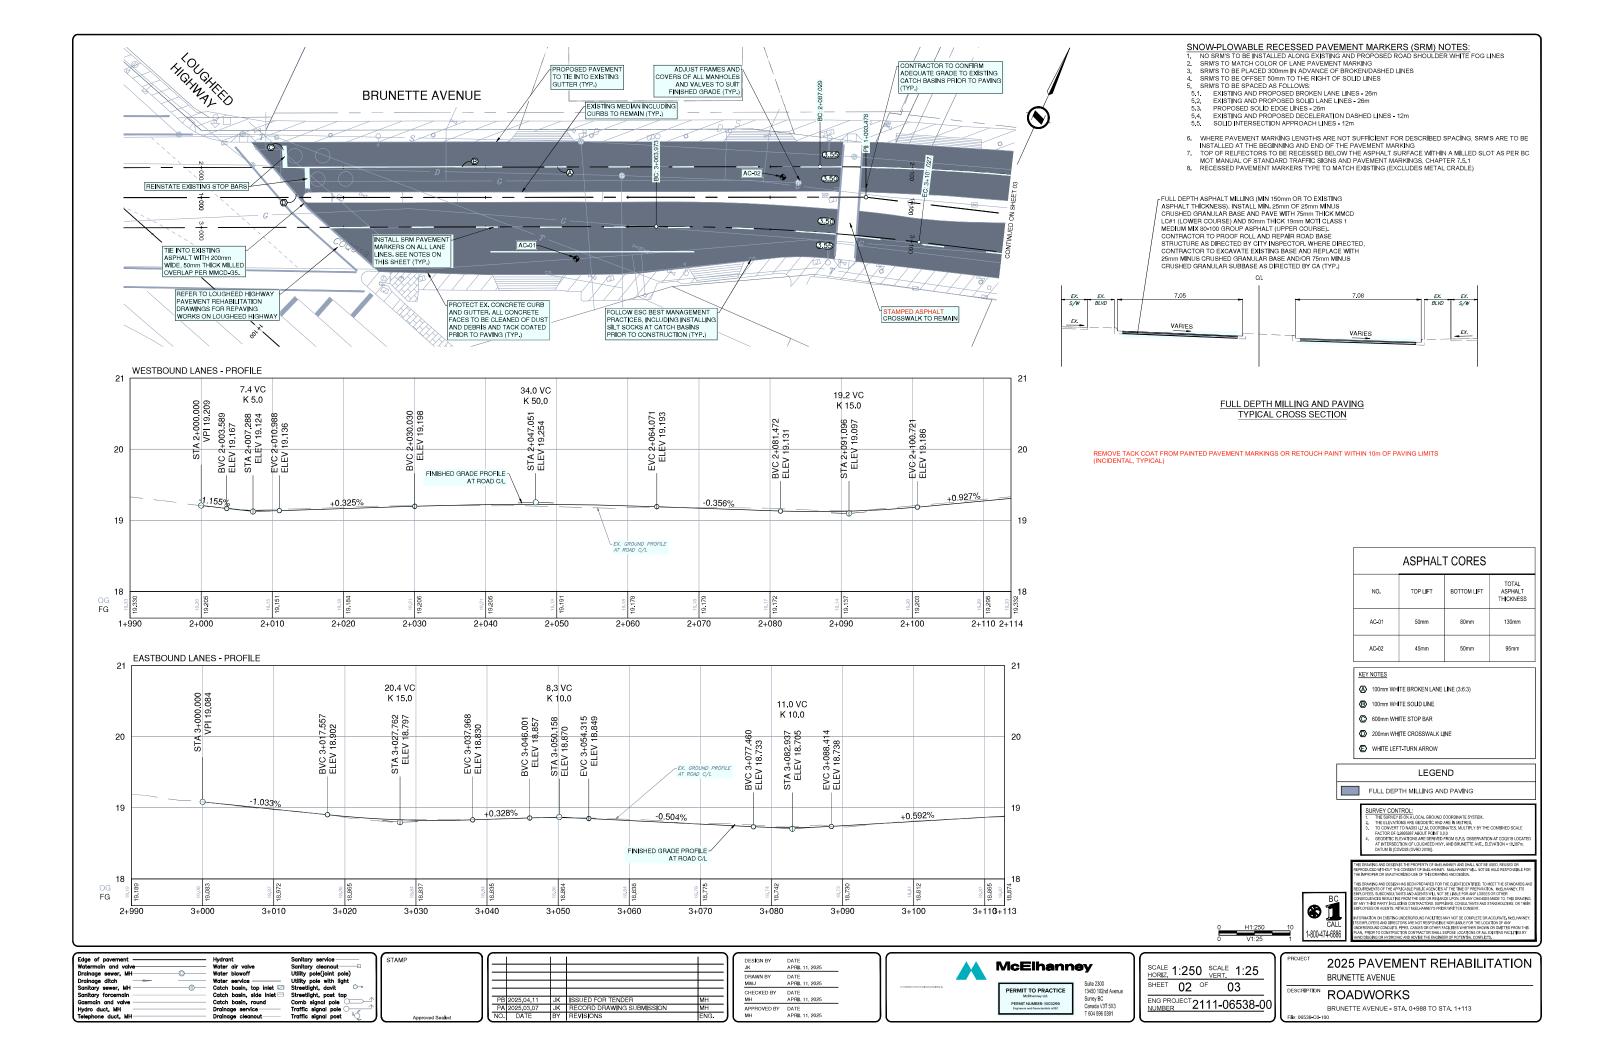

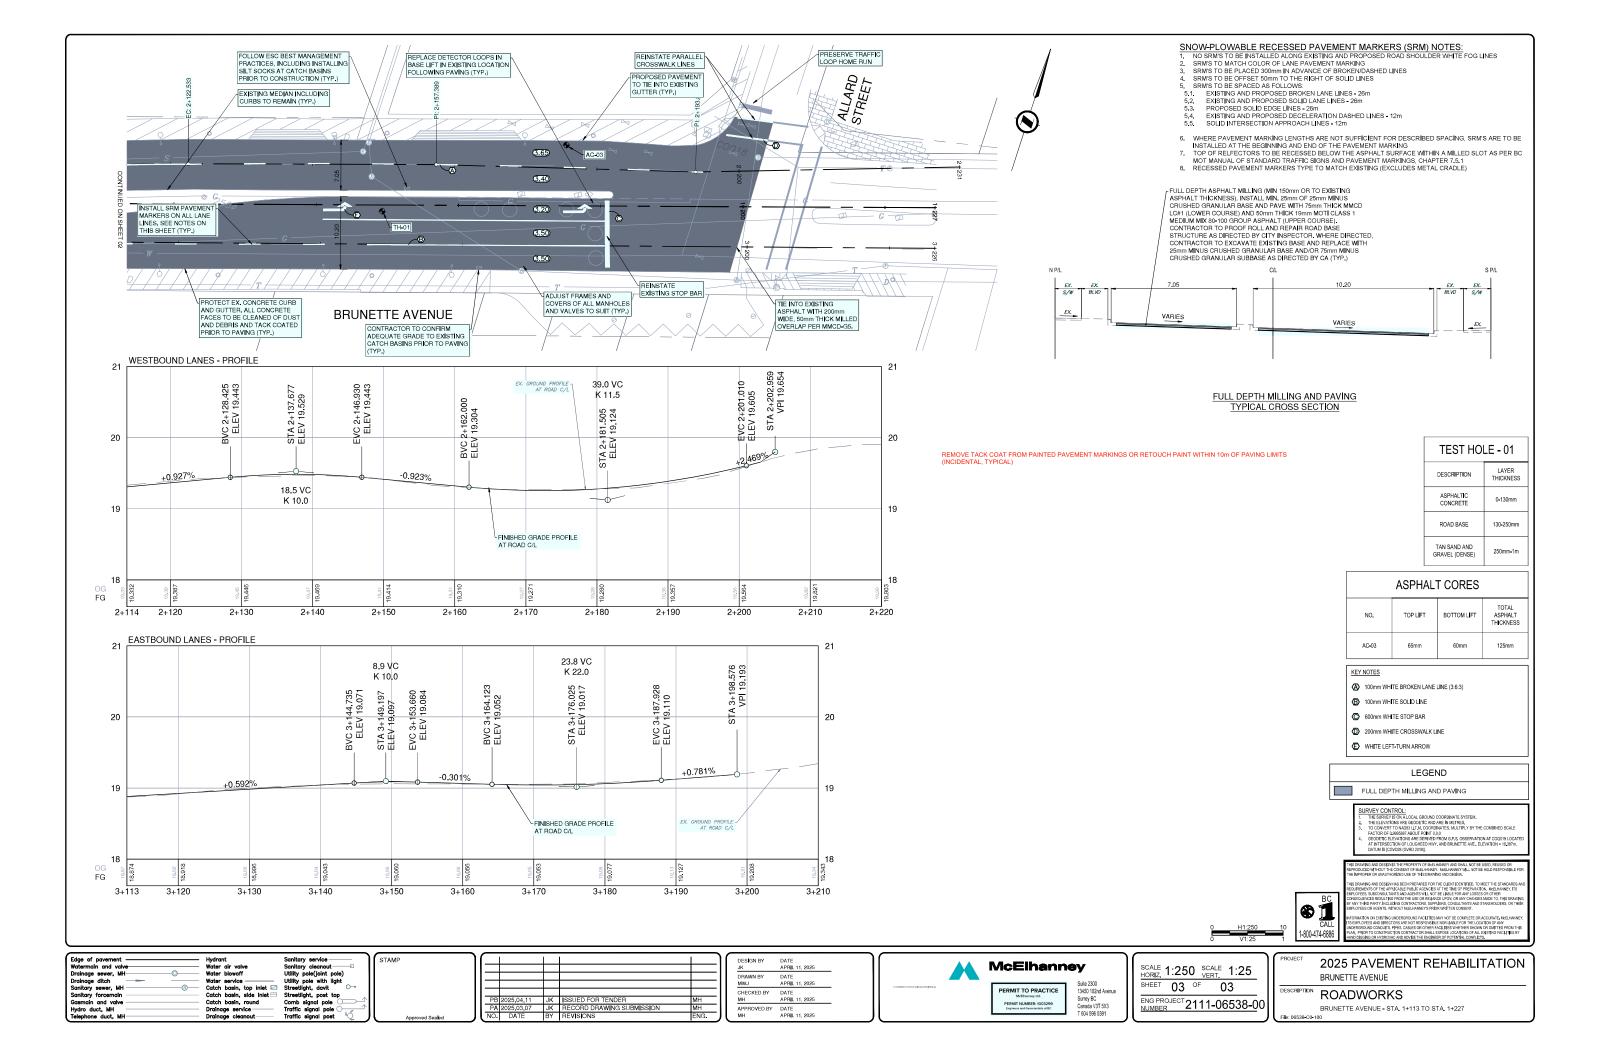





73389 - LOUGHEED HIGHWAY / UNITED BOULEVARD PAVEMENT REHABILITATION

ISSUED FOR TENDER

DRAWING SCHEDULE						
DWG. NO	SHEET TITLE	REV. NO				
00	COVER					
01	GENERAL NOTES	В				
02	LOUGHEED HWY AND KING EDWARD ST INTERSECTION	В				
03	UNITED BOULEVARD	D				

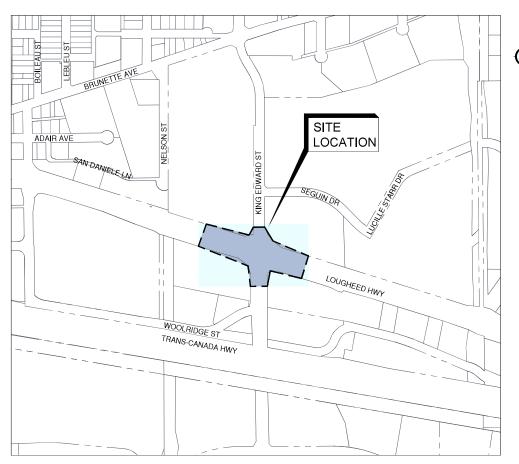

SITE PLAN LOUGHEED HIGHWAY / KING EDWARD STREET

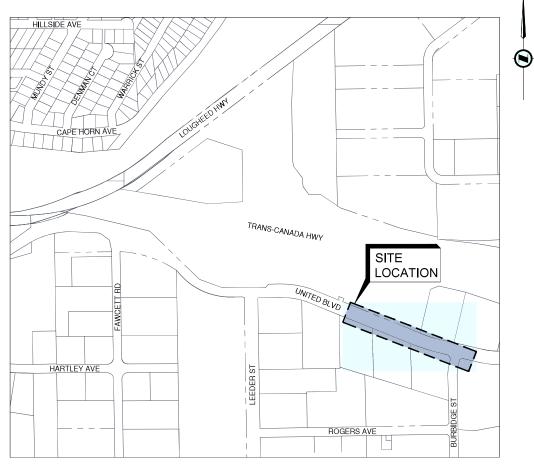

SITE PLAN
UNITED BOULEVARD







GENERAL NOTES:

- 1. ALL CONSTRUCTION AND MATERIALS SHALL BE IN ACCORDANCE WITH:
- THE MASTER MUNICIPAL CONSTRUCTION DOCUMENT AND STANDARD DETAIL DRAWINGS (MMCD 2019), LATEST EDITION (PLATINUM EDITION) AND CITY OF COQUITLAM SUPPLEMENTARY SPECIFICATIONS AND DETAILED DRAWINGS UNLESS OTHERWISE
- CONSTRUCTION PLANS, ACCEPTED AND SIGNED BY THE CITY OF.
- COQUITLAM;

 APPLICABLE CONTRACT DOCUMENTS AND ALL SPECIFICATIONS REFERENCED THEREIN;

 MINISTRY OF TRANSPORTATION "BC TRAFFIC CONTROL MANUAL FOR WORK ON ROADWAYS", LATEST EDITION; AND

 WORKSAFEBC, LATEST EDITION.

THE CONTRACTOR SHALL MAINTAIN ON SITE COPIES OF THE ABOVE DOCUMENTS AND SHALL ENSURE THAT ALL SUB CONTRACTORS ARE THOROUGHLY FAMILIAR WITH THE APPLICABLE SECTIONS OF THE

- 2. THE CONTRACTOR SHALL REPAIR OR REPLACE ANY EXISTING ROAD SURFACES, SERVICES, SIGNS, LANDSCAPING, DRIVEWAY LETDOWNS, PRIVATE LANDSCAPING, OR PRIVATE IMPROVEMENTS THAT MAY BE DAMAGED AS A RESULT OF CONSTRUCTION, REPAIRS TO EXISTING CITY SERVICES SUCH AS WATER, SANTARY SEWER, STORM SEWER, AND STREET OR TRAFFIC LIGHTING SHALL BE MADE BY THE OWNER AT COST TO THE CONTRACTOR, REPAIRS TO EXISTING SURFACE WORKS MAY BE DONE BY THE CONTRACTOR AT THE DISCRETION OF THE CONTRACT OR AT THE DISCRETION OF THE
- 3. THE LOCATION OF EXISTING UTILITIES IS COMPILED FROM OWNER AND THE LOCATION OF EXISTING UILLITIES IS COMPILED FROM OWNER AND UTILITY SUPPLIED RECORD DRAWINGS AND ARE CONSIDERED APPROXIMATE ONLY. THE EXACT LOCATION AND EXTENT OF UTILITIES SHOULD BE DETERMINED BY CONSULTING THE LOCAL AUTHORITIES AND UTILITY COMPANIES CONCERNED, THE CONTRACTOR SHALL VERIFY THE EXACT LOCATION AND INVERT ELEVATION BY HAND OR HYDROVAC EXCAVATION BEFORE CONSTRUCTION OF UTILITY CONCERNED. CROSSINGS AND SHALL BE RESPONSIBLE FOR RESTORATION OF ANY DAMAGE TO EXISTING UTILITIES. ANY COSTS ASSOCIATED WITH UTILITY CONFLICTS THAT WERE NOT PRELOCATED WILL BE THE CONTRACTORS DESPONSIBLE BY CONTRACTORS RESPONSIBILITY.
- REPORT ANY DISCREPANCIES TO THE CONTRACT ADMINISTRATOR A MIN 72 HOURS PRIOR TO CONSTRUCTION.
- RESTORATION OF ITEMS NOT SPECIFICALLY IDENTIFIED IN THE SCHEDULE OF QUANTITIES SHALL BE INCLUDED IN THE PAY ITEM MOST CLOSELY MATCHING THE WORK REQUIRED.
- 6. ALL SURVEY MONUMENTS, SURVEY PINS, OR LEAD PLUGS WITHIN THE ALL SURVEY MOVIMENTS, SURVEY PINDS, OR LEAD PLOUGS WITHIN THE PROJECT BOUNDARIES SHALL BE PROTECTED DURING THE COURSE OF THE WORK. SHOULD ANY SURVEY MONUMENT REQUIRE RAISING OR RELOCATION, THE CONTRACTOR SHALL NOTIFY THE OWNER'S ENGINEERING AND OPERATIONS DEPARTMENT AT LEAST FIVE (5) BUSINESS DAYS IN ADVANCE OF SCHEDULING WORK.
- 7. ALL ELEVATIONS ARE GEODETIC AND REFERENCED TO INTEGRATED SURVEY MONUMENT ELEVATIONS LOCATED ON ROAD RIGHT-OF-WAYS.
- ALL PUBLIC ROADWAYS AFFECTED BY THE WORKS SHALL BE KEPT IN A CLEAN STATE AT ALL TIMES AND FREE OF EQUIPMENT AND MATERIALS AT ALL TIMES WHEN CONSTRUCTION ACTIVITY IS NOT UNDERWAY, DUST CONTROL MEASURES SHALL ALSO BE EMPLOYED AS DIRECTED BY THE CONTRACT ADMINISTRATOR
- 9. THE CONTRACTOR IS SOLELY RESPONSIBLE FOR CONSTRUCTION MEANS, METHODS, TECHNIQUES, SEQUENCES AND PROCEDURES, AND FOR COORDINATINS THE VARIOUS PARTS OF THE WORK, THE CONTRACTOR IS RESPONSIBLE TO ENSURE THAT THERE IS NO DISRUPTION TO SERVICE, AND IF DISRUPTION IS ANTICIPATED, TO NOTIFY THE CONTRACT ADMINISTRATOR A MINIMUM OF 72 HOURS DELOS AND ALL CONTRACT ADMINISTRATOR A MINIMUM OF 72 HOURS DELOS AND ALL CONTRACT ADMINISTRATOR A MINIMUM OF 72 HOURS PRIOR, AND OBTAIN APPROVAL FOR THE DISRUPTION. ANY REQUIREMENTS FOR TEMPORARY WATER SERVICE ARE TO BE INCLUDED IN THE CONTRACTORS METHODOLOGY.
- 10. ALL ABANDONED CATCHBASIN LEADS SHALL BE SEALED WITH NON-SHRINKING GROUT.
- 11. ALL SINGLE CATCHBASINS LEADS TO BE 150mm IN DIAMETER SDR 28 PVC INSTALLED AT A MINIMUM SLOPE OF 2.0% SLOPE UNLESS

TRAFFIC MANAGEMENT, NOTIFICATION AND APPROVALS NOTES:

- THE CONTRACTOR SHALL PROVIDE CONSTRUCTION SIGNAGE, BARRIERS, FLASHING INDICATORS ACCORDING TO MOT, BC TRAFFIC CONTROL MANUAL, ETC. AT ALL TIMES TO ENSURE THE SAFETY OF THE PUBLIC. TRAFFIC CONTROL WILL BE REQUIRED FOR ALL CONSTRUCTION WORKS WITHIN THE TRAVELED PORTION OF THE ROAD. NO ROAD SHALL BE CLOSED WITHOUT THE WRITTEN CONSENT OF THE DIRECTOR OF ENGINEERING AND OPERATIONS.
- 2. THE CONTRACTOR SHALL BE RESPONSIBLE FOR THE DISPOSAL OF ALL EXCAVATED MATERIAL UNSUITABLE FOR REUSE AT A SUITABLE OFF-SITE DISPOSAL AREA, IN ACCORDANCE WITH ALL APPLICABLE REGULATIONS.
- 3. THE CONTRACTOR SHALL ENSURE THAT ALL APPROVALS REQUIRED FOR THE PROPOSED WORKS HAVE BEEN OBTAINED FROM ALL AUTHORITIES AND AGENCIES PRIOR TO COMMENCING THE WORK.
- 4. THE CONTRACTOR SHALL ARRANGE FOR, AND COORDINATE THE WORKS DONE BY:
- OWNER; AND
 FRANCHISE UTILITIES.
- 5. THE CONTRACTOR SHALL MAKE CONTACT WITH THE APPROPRIATE PERSONNEL AT LEAST 72 HOURS PRIOR TO THE WORK, SCHEDULING AND OTHER CONSTRUCTION CONSTRAINTS IMPOSED BY THESE WORKS SHALL BE TAKEN INTO ACCOUNT.
- 6. RESIDENTS DIRECTLY AFFECTED BY CONSTRUCTION OF THESE WORKS AND SERVICES SHALL BE GIVEN MINIMUM 5 DAYS WRITTEN NOTICE OF THE PROPOSED START OF CONSTRUCTION. THE CONTRACTOR IS TO DISTRIBUTE A NOTICE OF CONSTRUCTION LETTER TO ALL AFFECTED RESIDENTS AND BUSINESSES. LETTER TO DIRECT INQUIRIES TO CONTRACT ADMINISTRATOR. FOLLOWING CONSTRUCTION ACTIVITY ON ANY PRIVATE PROPERTY, A WRITTEN RELEASE MAY BE REQUIRED FROM THE PROPERTY OWNER AT THE DISCRETION OF THE OWNER.
- APPROVALS FOR REQUIRED TREE CUTTING OR TRIMMING NOT INDICATED IN CONTRACT DRAWINGS SHALL BE OBTAINED BY THE CONTRACTOR FROM THE OWNER PRIOR TO WORK BEING PERFORMED.
- 8. ALL TRAFFIC CONTROL TO CONFORM TO THE LATEST EDITION OF THE "BC TRAFFIC CONTROL MANUAL FOR WORK ON
- 9. APPROVAL OF NOISE VARIANCE FOR ALL WORK OUTSIDE OF NORMAL APPROVED WORK HOURS REQUIRED BY THE OWNER.
- 10. THE CONTRACTOR WILL BE RESPONSIBLE FOR COMPLETION OF ALL TAPED TEMPORARY AND PERMANENT PAINT AND THERMOPLASTIC PAVEMENT MARKINGS IN THE PLACE OF THE WORK. THE OWNER WILL NOT BE PROVIDING ROAD MARKING DRAWINGS FOR THE INSTALLATION OF PERMANENT MARKINGS. THE CONTRACTOR SHALL THEREFORE BE REQUIRED TO PERFORM ANY PRE AND POST-CONSTRUCTION SURVEY WORK ESSENTIAL FOR THE REINSTATEMENT OF PERMANENT PAVEMENT MARKINGS TO THEIR PRE-CONSTRUCTION LOCATIONS, TEMPORARY PAVEMENT MARKINGS ARE TO BE PLACED DALLY, PERMANENT LANE MARKINGS ARE TO BE PLACED DALLY, PERMANENT LANE MARKINGS ARE TO BE PLACED DALLY, PERMANENT LANE MARKINGS ARE TO BE PLACED WITHIN SEVENTY-TWO (72) HOURS OF FINAL PAVING AND PERMANENT THERMOPLASTIC PAVEMENT MARKINGS ARE TO BE PLACED WITHIN FIVE (5) DAYS OF EINAL PAVING. (5) DAYS OF FINAL PAVING.
- 11. ALL TEMPORARY MARKINGS ARE TO BE REMOVED IMMEDIATELY FOLLOWING INSTALLATION OF THE PERMANENT MARKINGS.

EV NO. REVISION DESCRIPTION A DETAILED DESIGN

Coouitlam






34157 CREATION DATE JAN-2025 AS SHOWN 03 HECKED BY CJB APPROVED BY CJB v. B OT DATE July 22, 2025

ISSUED FOR TENDER DESIGN NO

GENERAL NOTES LOUGHEED HWY AND UNITED BLVD PAVEMENT REHAB

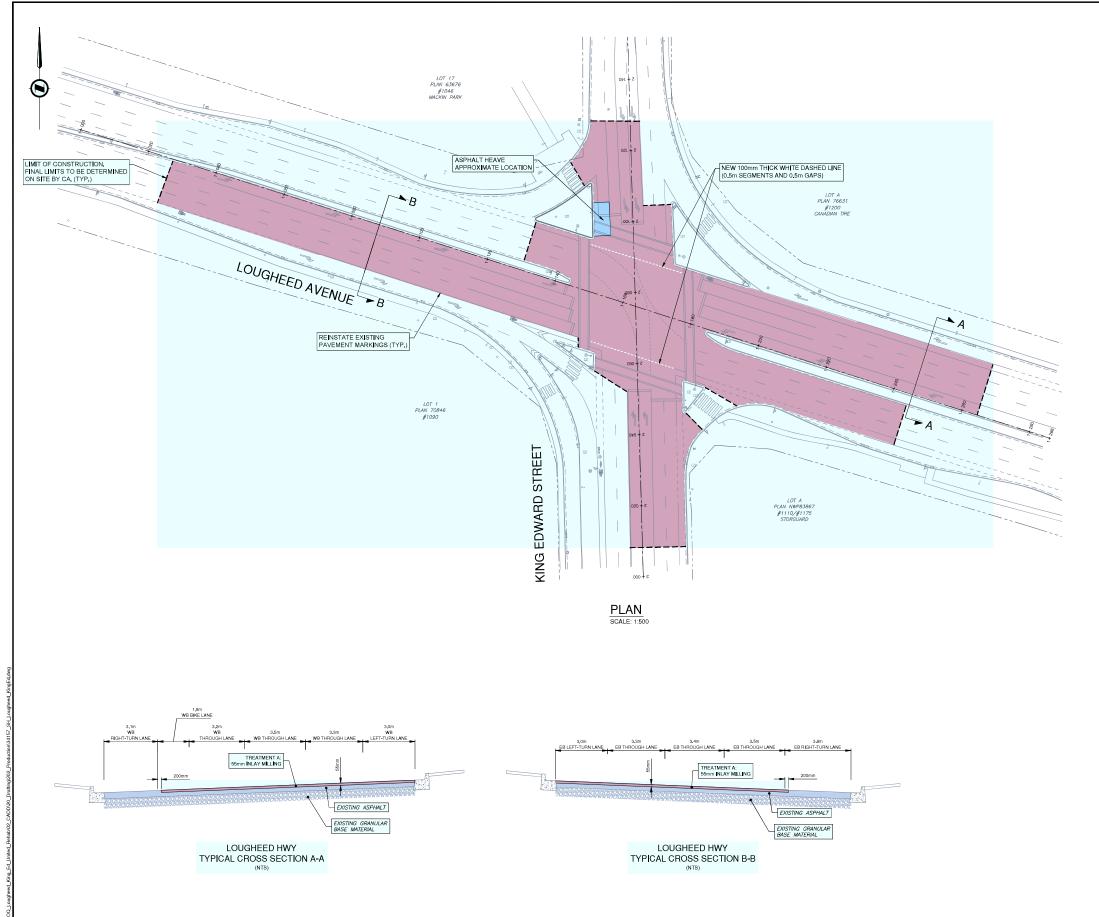

TREATMENT A: 55mm INLAY MILL AND PAVING

- DETERMINE FINAL LIMITS OF ROAD TREATMENT WITH CONTRACT ADMINISTRATOR.
- 2. SURFACE MILL THE EXISTING ASPHALT ROAD TO A DEPTH OF 55mm.
- 4. INLAY (MITH PAVER) MILLED AREA WITH NEW HOT MIX ASPHALT TO 55mm THICKNESS (USE MOTI CLASS 1, 19mm MEDIUM MIX WITH 70-22P GROUP A ASPHALT BINDER, COMPACTED TO NO LESS THAN 97% OF 75 BLOW MARSHALL DENSITY).
- 5. SEAL ALL CONSTRUCTION JOINTS FOLLOWING THE COMPLETION OF PAVING, AND PRIOR TO INSTALLATION OF PAINT LINES.

TREATMENT B: 150mm FULL DEPTH MILL AND PAVING

DETERMINE FINAL LIMITS OF ROAD TREATMENT WITH CONTRACT ADMINISTRATOR.

- 2. FULL DEPTH MILL THE EXISTING ASPHALT SURFACES & GRAVEL TO A DEPTH OF MIN
- SUPPLEMENT WITH 25mm MINUS GRANULAR BASE MATERIAL, RESHAPE TO PROPOSED GRADES AND COMPACT TO NO LESS THAN 95% MODIFIED PROCTOR DENSITY.
- PLACE (WITH PAVER) BASE LIFT OF NEW HOT MIX ASPHALT TO THICKNESS (USE MIXCD STANDARD LOWER COURSE #1 MIXTURE, COMPACTED TO NO LESS THAN 97% OF 75 BLOW MARSHALL DENSITY).
- 5. CLEAN AND TACK-COAT ALL ASPHALT SURFACES INCLUDING JOINTS.
- PLACE (WITH PAVER) TOP LIFT OF NEW HOT MIX ASPHALT TO 55mm THICKNESS (USE MOTI CLASS 1, 19mm MEDIUM MIX WITH 70-22P GROUP A ASPHALT BINDER, COMPACTED TO NO LESS THAN 97% OF 78 BLOW MARSHALL DENSITY).
- 7. SEAL ALL CONSTRUCTION JOINTS FOLLOWING THE COMPLETION OF PAVING, AND PRIOR TO INSTALLATION OF PAINT LINES.

- SNOWPLOWABLE RECESSED PAVEMENT MARKERS (BY OTHERS) TO BE INSTALLED AS FOLLOWS:
 SHALL BE PLACED AT A SPACING OF 18m (MAX) RESULTING IN A RPM EVERY SECOND DASHED LINE
 SHALL BE PLACED 300mm IN ADVANCE OF DASHED LINES
 SHALL INCLUDE DECELERATION DASHED LINES
 SHALL BEPLACED AT 13m INTERVALS AT SOLID INTERSECTIONS & DECELERATION APPROACH LINES (OFFSET 50mm TO RIGHT OF LANE LINE).

- 2. ALL MANHOLES & WATER VALVE FRAME & LID CASTINGS ARE TO BE REMOVED AND REPLACED.
- 3. CLEAN OR TOUCH-UP ALL PAINTED LINES COVERED IN TACK COAT WITHIN 10m OF NEW ASPHALT. (INCIDENTAL, TYPICAL)

ISSUED FOR TENDER DESIGN NO.

34157











	SCALE	AS SHOWN	CREATION DATE	JAN-2025	DWG. NO.
	DRAWN BY	DW/GA	DESIGN BY	CJB	02 of
	CHECKED BY	CJB	APPROVED BY	CJB	03
'	PLOT DATE	July 22, 2025			REV. B

NOTES

ALL MANHOLES & WATER VALVE FRAME & LID CASTINGS ARE TO BE REMOVED AND REPLACED.

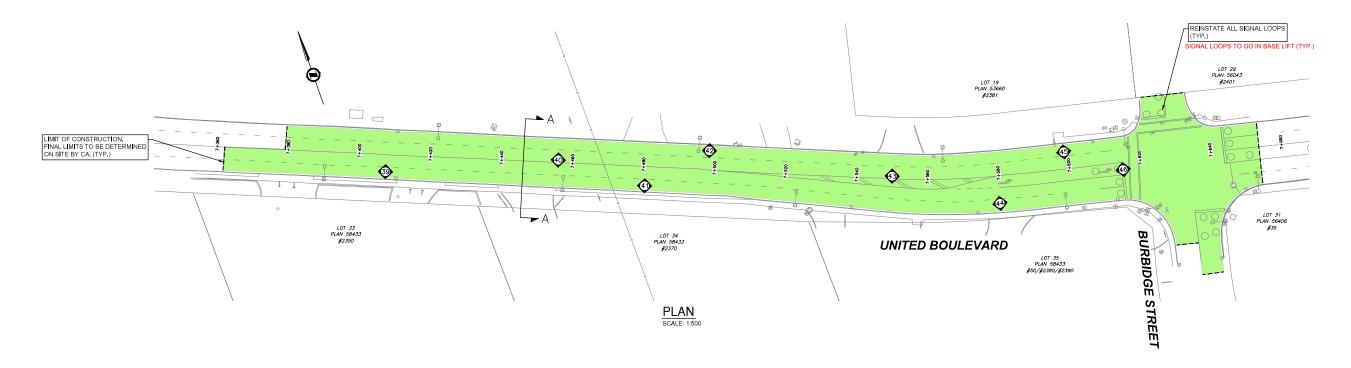

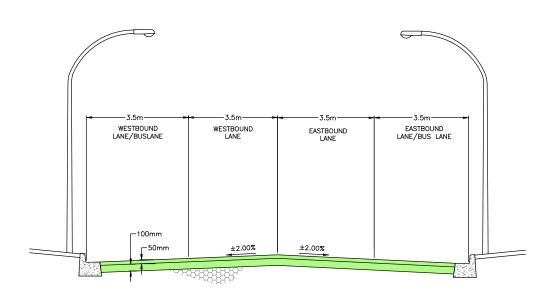

UNITED BOULEVARD TYPICAL CROSS SECTION

UNITED BOULEVARD CORE INFO (APR 2015):

CORE NO.	CORE REPORT REF NO.	APPROX STA:	LOCATION	TOTAL TH I CKNESS	TOP THICKNESS	COMMENTS
39	1	7+408	1.8m FROM SOUTH SIDE EASTBOUND/SLOW LANE	100	70	
40	8	7+454	7.0m FROM NORTH SIDE EASTBOUND/FAST LANE	115	45	RUTT I NG
41	2	7+479	1.5m FROM SOUTH SIDE EASTBOUND/SLOW LANE	125	50	
42	5	7+497	1.8m FROM NORTH SIDE WESTBOUND/SLOW LANE	115	45	
43	7	7+549	6.0m FROM NORTH SIDE EASTBOUND/FAST LANE	115	45	
44	3	7+578	2.5m FROM SOUTH SIDE EASTBOUND/SLOW LANE	143	60	
45	4	7+599	1.8m FROM NORTH SIDE WESTBOUND/SLOW LANE	110	40	NO BOND
46	6	7+613	8.3m FROM SOUTH SIDE EASTBOUND/TURN LANE	115	45	

TREATMENT C: 150mm FULL DEPTH MILL AND PAVING

- DETERMINE FINAL LIMITS OF ROAD TREATMENT WITH CONTRACT ADMINISTRATOR.
- 2. FULL DEPTH MILL THE EXISTING ASPHALT SURFACES & GRAVEL TO A DEPTH OF MIN
- 3. SUPPLEMENT WITH 25mm MINUS GRANULAR BASE MATERIAL, RESHAPE TO PROPOSED GRADES AND COMPACT TO NO LESS THAN 95% MODIFIED PROCTOR DENSITY
- 4. PROOF ROLL AND OVEREXCAVATE WHERE REQUIRED AS DIRECTED BY THE CONTRACT ADMINISTRATOR.
- PLACE (WITH PAVER) BASE LIFT OF NEW HOT MIX ASPHALT TO 100mm THICKNESS (USE MMCD STANDARD LOWER COURSE #1 MIXTURE, COMPACTED TO NO LESS THAN 97% OF 75 BLOW MARSHALL DENSITY).
- 6. CLEAN AND TACK-COAT ALL ASPHALT SURFACES INCLUDING JOINTS.
- PLACE (WITH PAVER) TOP LIFT OF NEW HOT MIX ASPHALT TO 50mm THICKNESS (USE MOTI CLASS 1, 19mm MEDIUM MIX WITH 70-22P GROUP A ASPHALT BINDER, COMPACTED TO NO LESS THAN 97% OF 75 BLOW MARSHALL DENSITY).
- 8. SEAL ALL CONSTRUCTION JOINTS FOLLOWING THE COMPLETION OF PAVING, AND PRIOR TO INSTALLATION OF PAINT LINES.
- 9. CLEAN OR TOUCH-UP ALL PAINTED LINES COVERED IN TACK COAT WITHIN 10m OF NEW ASPHALT. (INCIDENTAL, TYPICAL)



ISSUED FOR TENDER DESIGN NO.

34157

 REV NO.
 REVISION DESCRIPTION
 DATE
 DRAWN
 APPRID

 A
 DETALED DESIGN
 2015/05/22
 NMW
 KPT

 B
 100% DETALLED DESIGN
 2015/08/25
 NMW
 KPT

 C
 100% DETALLED DESIGN - RESUBMISSION
 2025/03/07
 GA
 CJB

 D
 ISSUED FOR TENDER
 2025/07/22
 DW
 GA

Coouitlam

ROAD WORKS UNITED BOULEVARD PAVEMENT REHABILITATION





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	SCALE	AS SHOWN	CREATION DATE	APR-2015	DWG. NO.
	DRAWN BY	NMW	DESIGN BY	CJB/NMW	03 of
	CHECKED BY	CJB	APPROVED BY	GA	03
9	PLOT DATE	July 22, 2025			REV. D