
CITY OF COQUITLAM

3000 GUILDFORD WAY, COQUITLAM, BC V3B 7N2

CAYER ST AND BRUNETTE AVE ACCESSIBILITY IMPROVEMENTS

ISSUED FOR TENDER



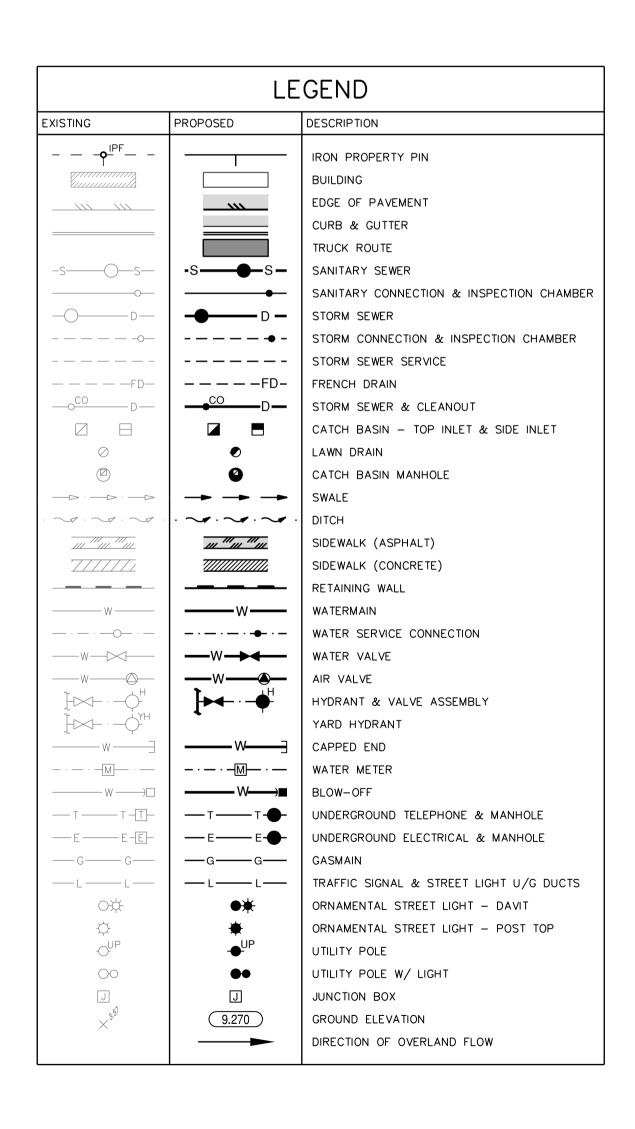

DRAWING INDEX				
SHEET #	DWG. TYPE	STREET	LIMITS	RFB DWG. #
00	COVER SHEET			
01	GENERAL NOTES	BRUNETTE AVE AND CAYER ST		20-1027-6-R1
02	ROADWORKS - PLAN AND PROFILE	BRUNETTE AVE	AT CAYER ST	20-1027-6-R2
1 OF 1	RRFB - SITE PLAN AND DETAILS	BRUNETTE AVE AT CAYER ST		





R.F. BINNIE & ASSOCIATES LTD.
300 - 4940 Canada Way,

Burnaby, BC V5G 4K6
TEL 604 420 1721

BINNIE.com

GENERAL CONSTRUCTION NOTES


- ALL MATERIALS SUPPLIED AND CONSTRUCTION PERFORMED SHALL BE IN ACCORDANCE WITH THE CITY OF COQUITLAM SUBDIVISION AND DEVELOPMENT SERVICING BYLAW No. 3558, THE 2009 MMCD PLATINUM BOOK, AND THE CURRENT COQUITLAM SUPPLEMENTARY SPECIFICATIONS AND DETAILED DRAWINGS.
- 2. REMOVE AND DISPOSE OF EX AC PIPE IN ACCORDANCE WITH WORKSAFE BC AND OTHER PERTINENT REGULATIONS.
- 3. ALL EXCAVATION WITHIN EXISTING TREE DRIPLINES TO BE BY HAND OR HYDRO-VAC.
- 4. CONTRACTOR SHALL RECORD COMPLETE AND ACCURATE AS-BUILT INFORMATION ON A SET OF CURRENT CONSTRUCTION DRAWINGS DURING CONSTRUCTION AND SUBMIT THE INFORMATION TO THE CONTRACT ADMINISTRATOR (CA). AS-BUILT INFORMATION SHALL INCLUDE:
- LIMITS OF PAVEMENT REPAIRS
- PIPE INVERTS
- PIPE GRADES
- VALVE AND FITTING LOCATIONS
- SERVICE WYE LOCATIONS
- CONNECTIONS
- BENDS
- MANHOLES
- SERVICE ELEVATIONS @ IC'S PROPERTY LINE OFFSETS
- 5. THE LOCATIONS OF THE EXISTING UTILITIES, AS SHOWN ON THE DESIGN DRAWINGS, ARE APPROXIMATE ONLY AND THIS INFORMATION MAY NOT BE FULLY ACCURATE OR COMPLETE. PRIOR TO THE START OF CONSTRUCTION, THE CONTRACTOR SHALL LOCATE AND EXPOSE ALL EXISTING UTILITIES AT ALL TIE-IN POINTS, AT ALL POINTS WHERE A CONFLICT MAY ARISE DURING THE CONSTRUCTION OF THE PROPOSED WORKS, AND TO CONFIRM DESIGN ELEVATIONS. IN THE EVENT OF A CONFLICT, THE CONTRACTOR SHALL IMMEDIATELY NOTIFY THE CONTRACT ADMINISTRATOR.
- 6. EXISTING UNDERGROUND UTILITY TRENCHES ADJACENT TO THE PROPOSED UNDERGROUND UTILITY INSTALLATION SHALL BE ADEQUATELY PROTECTED FROM SLOUGHING IN ORDER TO PREVENT OVER-WIDTH EXCAVATION.
- 7. ALL SURVEY MONUMENTS, BENCHMARKS, AND LEGAL PINS MUST BE PROTECTED AND ANY DAMAGE CAUSED BY THE CONTRACTOR SHALL BE REPAIRED AT THE CONTRACTOR'S

CONTRACTOR TO IDENTIFY ANY SURVEY MONUMENTS AND LEAD PLUGS THAT MAY BE DISTURBED DURING CONSTRUCTION AND ARRANGE WITH THE OWNER'S SURVEY DEPARTMENT 5 DAYS PRIOR TO CONSTRUCTION TO REFERENCE LOCATIONS BEFORE WORK COMMENCES.

8. THE CONSULTANT WILL PROVIDE THE CONTRACTOR WITH HORIZONTAL AND VERTICAL SURVEY CONTROLS. THE CONTRACTOR SHALL GIVE NOTICE OF HIS SURVEY REQUIREMENTS AT LEAST TWO WORKING DAYS IN ADVANCE OF THE WORK AND SHALL PROTECT AND MAINTAIN THE CONTROLS PROVIDED. THE CONTRACTOR SHALL ENSURE THAT THE AREAS RECEIVING THE CONTROLS ARE UNOBSTRUCTED AND CLEAR OF DEBRIS, EQUIPMENT, EXCAVATIONS AND ANY OTHER WORK PRIOR TO REQUESTING THE CONTROLS. RE-ESTABLISHMENT OF CONTROLS, SURVEY POSTS AND BENCHMARKS WHICH ARE DAMAGED OR LOST SHALL BE AT THE CONTRACTOR'S EXPENSE.

ROADWORKS NOTES

- 1. CONTRACTOR TO ADJUST ALL CATCH BASINS, MANHOLES, VALVE COVERS, AND ALL OTHER APPURTENANCES TO SUIT FINISHED GRADES.
- 2. CONTRACTOR TO REMOVE AND REPLACE INDIVIDUAL DAMAGED SIDEWALK PANELS AND DAMAGED CURB AND GUTTER SECTIONS AS DIRECTED BY THE CONTRACT ADMINISTRATOR.
- 3. ALL PAVEMENT MARKINGS TO BE REINSTATED IN THE PLACE OF WORK UNLESS NOTED OTHERWISE. CONTRACTOR IS RESPONSIBLE TO PERFORM PRE AND POST CONSTRUCTION SURVEY WORK FOR THE REINSTATEMENT OF PAVEMENT MARKINGS.
- 4. LOCATIONS OF DRIVEWAYS AND WHEELCHAIR RAMPS SHALL BE CONFIRMED IN THE FIELD PRIOR TO CONSTRUCTION OF CURB AND GUTTER.
- 5. CHANGES IN GRADE SHALL BE FORMED WITH SMOOTH CURVES.
- 6. CATCH BASIN RIM ELEVATIONS SHALL BE SET 30mm BELOW THE FINISHED GUTTER LINE GRADES. THE GUTTER AND ROAD SURFACE AREA TO BE SHAPED TO FORM A DISH AROUND THE INLET.
- 7. ALL ASPHALT JOINTS MUST BE SMOOTH AND WITHOUT VISIBLE BREAKS IN THE GRADE. THOROUGHLY COMPACTED NEAT JOINTS ARE REQUIRED. CONTRACTOR TO SUBMIT DENSITY TESTS TAKEN ON JOINTS. NO INDIVIDUAL TESTS SHALL BE LESS THAN 95% OF 75 BLOW MARSHALL DENSITY.
- 8. RAISED PAVEMENT MARKERS (RPMs) TO BE INSTALLED BY OTHERS.

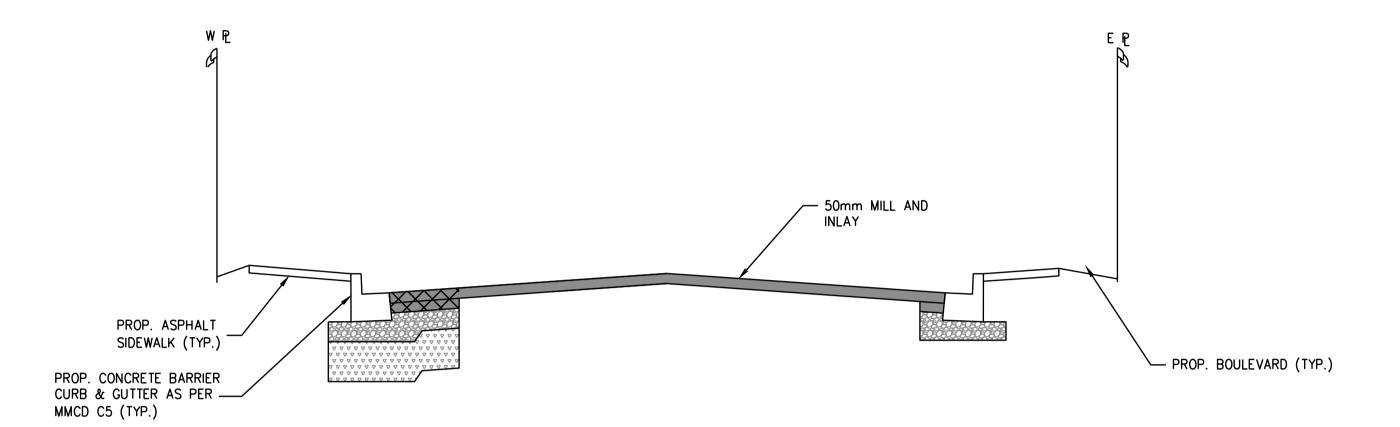

CAYER STREET TYPICAL SECTION LANEWAY TO BRUNETTE AVENUE

N.T.S

MARINER WAY TREATMENT:

50mm MILL & INLAY (WHERE SHADED IN PLAN VIEW):

- . MILL TREATMENT AREA TO 50mm DEPTH BELOW DESIGN
- FINISH GRADE. 2. CLEAN AND TACK COAT ALL ASPHALT SURFACES
- INCLUDING JOINTS.
- 3. PLACE (WITH PAVER) NEW HOT MIX ASPHALT MMCD, UPPER COURSE #1 THICKNESS IN 1 LIFT, AND COMPACT TO 97% OF 75 BLOW MARSHALL. THE FINAL ASPHALT LIFT MUST HAVE ONLY ONE JOINT LOCATED UNDER THE ROAD CENTERLINE.

FULL DEPTH STRUCTURE (WHERE HATCHED IN PLAN VIEW):

- MILL FULL EXCAVATION TO (MINIMUM 400mm BELOW DESIGN FINISH GRADE). FINAL LIMITS OF FULL DEPTH TREATMENT TO BE DETERMINED BY C.A.
- 2. PROOF ROLL AND OVER-EXCAVATE WHERE REQUIRED. AS DIRECTED BY C.A.
- 3. PLACE 200mm OF 75MM MINUS GRANULAR SUBBASE MATERIAL, AND COMPACT TO
- NO LESS THAN 95% MPMDD. (PROVISIONAL) 4. PLACE 100mm OF 19MM MINUS GRANULAR BASE MATERIAL TO ACHIEVE CROSS
- SLOPES, AND COMPACT TO NO LESS THAN 95% MPMDD. (PROVISIONAL)
- 5. PLACE (WITH PAVER) NEW HOT MIX ASPHALT (MMCD LOWER COURSE #1) TO 50mm THICKNESS, AND COMPACT TO 97% OF 75 BLOW MARSHALL.
- 6. CLEAN AND TACK COAT ALL ASPHALT SURFACES INCLUDING JOINTS.
- 7. PLACE (WITH PAVER) NEW HOT MIX ASPHALT (MMCD UPPER COURSE #1) TO 50mm THICKNESS, AND COMPACT TO 97% OF 75 BLOW MARSHALL. THE FINAL ASPHALT
- LIFT MUST HAVE ONLY ONE JOINT LOCATED UNDER THE ROAD CENTERLINE. 8. THE BOTTOM LIFT OF ASPHALT SHALL BE PAVED SUCH THAT ITS CONSTRUCTION
- JOINT IS OFFSET 300mm FROM THE TOP LIFT ASPHALT PAVING JOINTS. 9. TOP LIFT ASPHALT PAVING LONGITUDINAL JOINTS TO BE LOCATED UNDER THE
- DOUBLE YELLOW LINE MARKINGS. 10. CONTRACTOR TO USE PROPER PAVING TECHNIQUE, MAT OVERLAY OR ECHELON
- 11. SEAL ALL CONSTRUCTION JOINTS FOLLOWING THE COMPLETION OF PAVING, AND PRIOR TO INSTALLATION OF THERMOPLASTIC PAINT.

NOT TO SCALE

Edge of pavement

Hydro duct, MH

Watermain and valve -

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- Water air valve

∼Water service-

— Catch basin, top inlet

-Drainage service -

– Drainage cleanout

–Catch basin, side inlet 🗀

Sanitary service-

Sanitary cleanout

Streetlight, davit

Comb signal pole

Traffic signal pole

Junction box

Streetlight, post top

Utility pole(joint pole)

Utility pole with light

Hydro Guy Wire

Vegetation Conifer

Vegetation Shrub

Survey Iron Pin


Survey Lead Plug

Survey Monument

Survey Traverse Hub

Vegetation Deciduous 😲

Hydro Kiosk

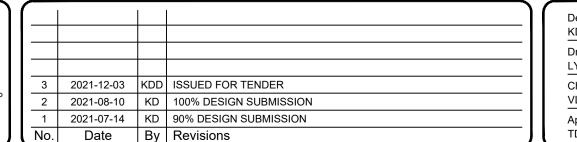

Design by KD	Date	
Drawn by LY	Date	
Checked by VL	Date	
Approved by TDB	Date	





3000 Guildford Way, Coquitlam, B.C. V3B 7N2

Sheet 01

Scale N.T.S. Scale N.T.S. Eng. Project No. 20-1027

ISSUED FOR TENDER

BRUNETTE AVE AND CAYER ST

Description GENERAL NOTES

File: 20-1027-6-R1

REV. 3

Droinage ditch

Sanitary sewer, MH ----- S -----

FOR MARSHALL MIX 97% (TYP.) 4. OVER-EXCAVATE (OPTIONAL):

WHERE DIRECTED BY THE CA, EXCAVATE UNSUITABLE MATERIAL AND REPLACE WITH IMPORTED BASE GRAVEL COMPACTED IN

5. CONTRACTOR TO REPLACE ALL MANHOLE FRAMES AND LIDS; WATER VALVE BOXES AND COVERS WITHIN THE ROADWAY.

6. THE ADJUSTMENT OF MANHOLES, VALVE COVERS, AND ALL OTHER APPURTENANCES TO SUIT NEW ASPHALT GRADES IS INCIDENTAL TO ASPHALT PAVING UNLESS SPECIFIED OTHERWISE IN THE SCHEDULE OF QUANTITIES. (TYP.)

7. ALL PAVEMENT MARKINGS TO BE REINSTATED IN THE PLACE OF WORK. CONTRACTOR RESPONSIBLE TO PERFORM PRE AND POST CONSTRUCTION SURVEY WORK ESSENTIAL FOR THE REINSTATEMENT OF PAVEMENT MARKINGS.

8. CONTRACTOR TO IDENTIFY ANY SURVEY MONUMENTS AND LEAD PLUGS THAT MAY BE DISTURBED DURING CONSTRUCTION AND ARRANGE WITH THE OWNER'S SURVEY DEPARTMENT 5 DAYS PRIOR TO CONSTRUCTION TO REFERENCE

9. CATCH BASINS RIM ELEVATIONS TO BE SET 30mm BELOW THE FINISHED GUTTERLINE GRADES. GUTTER AND ROAD SURFACE AREA TO BE SHAPED TO FORM A DISH AROUND THE INLET.

LOCATIONS BEFORE WORK COMMENCES.

10. FINAL LAYOUT OF LETDOWN AND TACTILE TO BE APPROVED BY CA. ADJUSTMENTS TO BE MADE ON SITE (TYP.)

11. SIDEWALK PANELS TO BE THICKEN TO 190mm ON ALL LETDOWN CROSSINGS, UP TO ONE PANEL PAST THE CURB RAMP (TYP.)

TREATMENT - MILLED OVERLAY

MILL 50mm OF EX. ASPHALT AND ADD 50mm OF MMCD UPPER COURSE #1 ASPHALT

ROAD WIDENING (FULL DEPTH STRUCTURE)

• 50mm MMCD UPPER COURSE #1 ASPHALT • 50mm MMCD LOWER COURSE #1

ASPHALT 100mm-19mm MINUS GRANULAR BASE


(PROVISIONAL) 200mm-75mm MINUS GRANULAR SUBBASE ON APPROVED FILL MATERIAL


AND SUBBASE. (PROVISIONAL)

REFER TO 20-1027-6-R1 DWG FOR GENERAL CONSTRUCTION, AND ROADWORKS NOTES.

BENCHMARK:


SURVEY CONTROL MONUMENT 73H0124 LOCATED AT JUNCTION OF BRUNETTE AVE & CAYER ST ELEVATION = 13.945 M CVD28GVRD2018

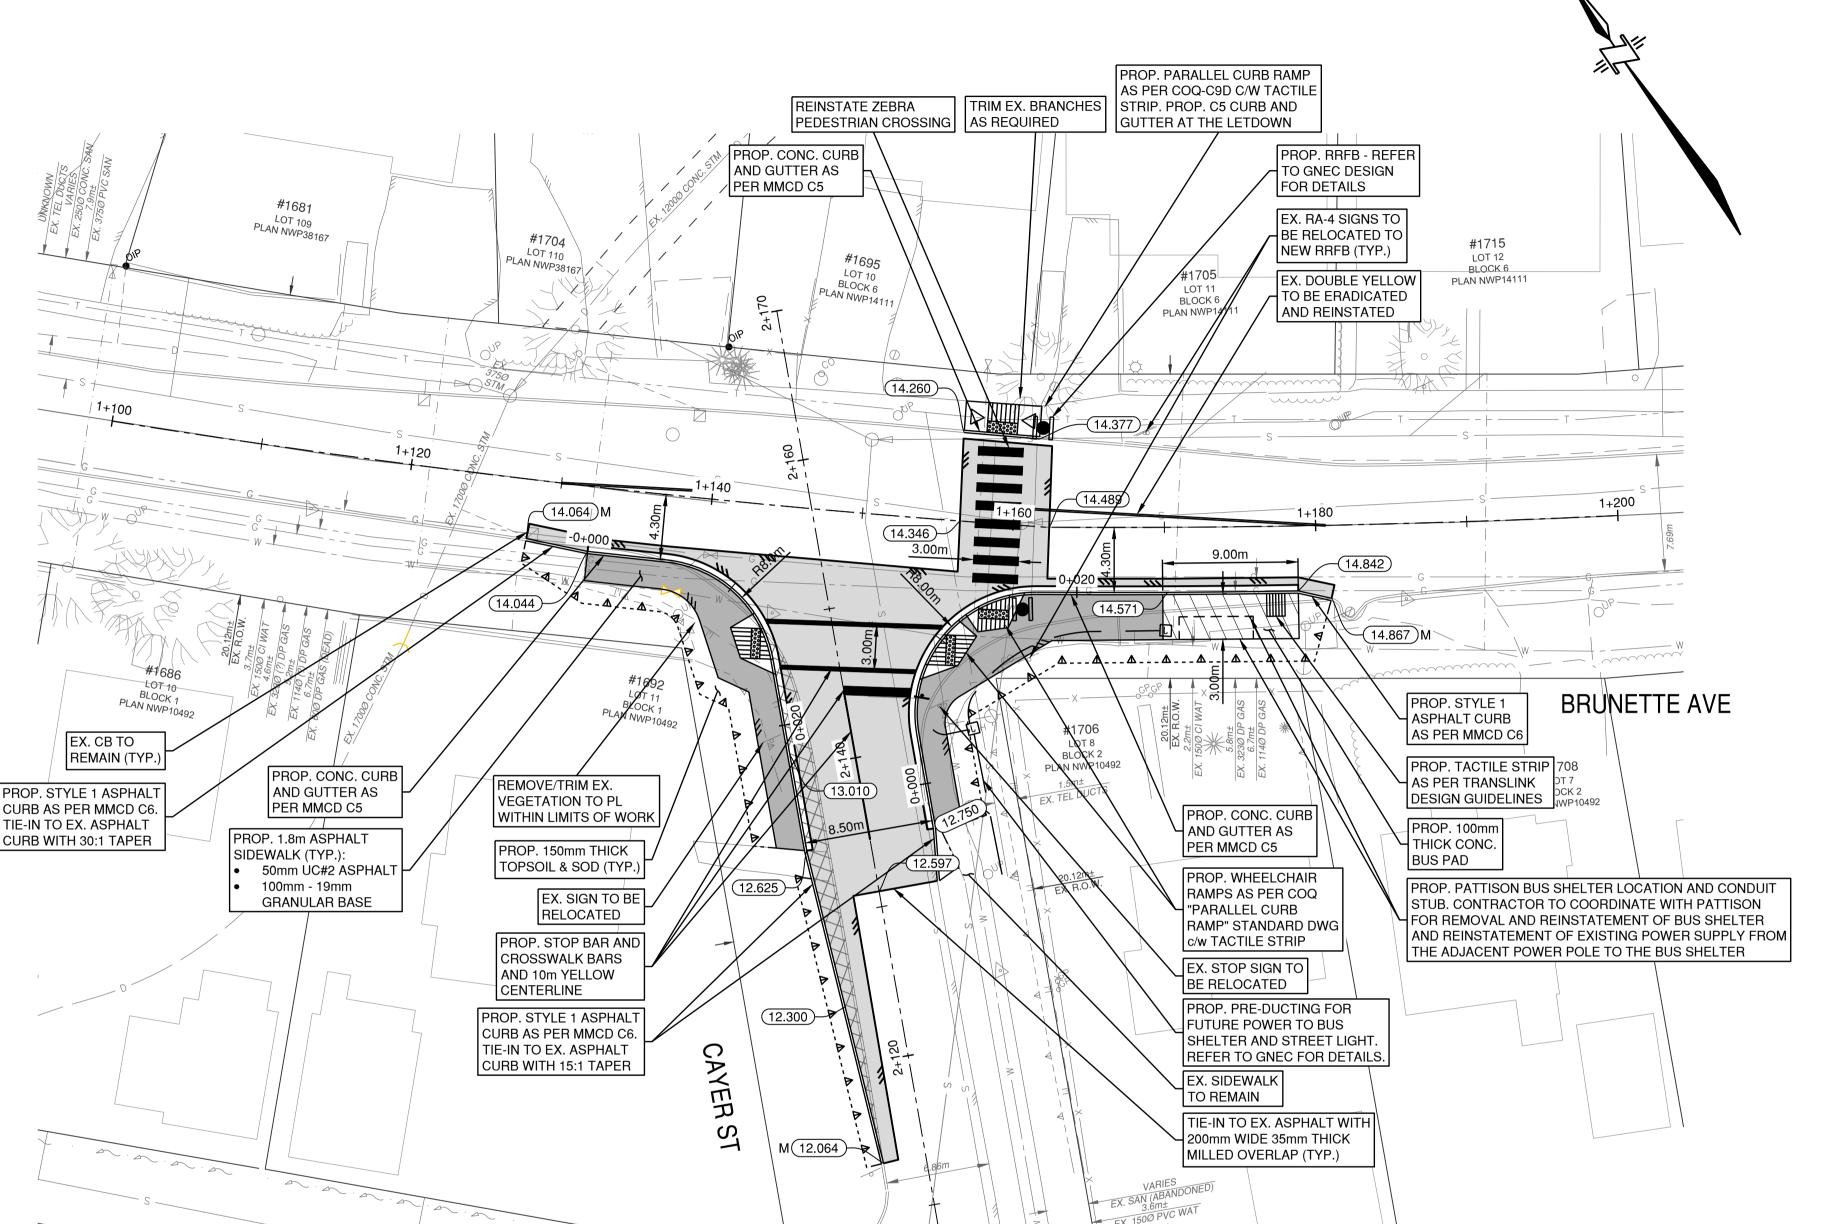

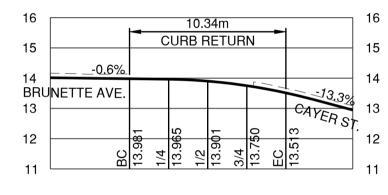

BRUNETTE AVE. CURB RETURN - SOUTHWEST

SCALE H 1:250 V 1:125

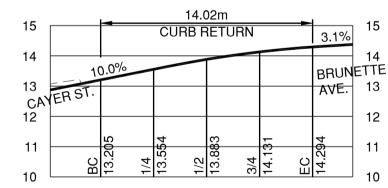

BRUNETTE AVE.

CURB RETURN - SOUTHEAST SCALE H 1:250 V 1:125

H 1:250 10m

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Drainage cleanout

Sanitary cleanout

Traffic signal pole

Junction box

Utility pole(joint pole)

Hydro Guy Wire


Hydro Guy Wire	\rightarrow	[]			
Hydro Kiosk	Н				
Vegetation Conifer	•	-			
Vegetation Deciduous	፡ □	l			
Vegetation Shrub	@				
Survey Traverse Hub	Δ _{OIP}	3	2021-12-03	KDD	ISSUED FOR TENDER
Survey Iron Pin	OIP	2	2021-08-10	KD	100% DESIGN SUBMISSION
Survey Lead Plug		1	2021-07-14	KD	90% DESIGN SUBMISSION
Survey Monument		No.	Date	Ву	Revisions

Design by KD	Date	
Drawn by LY	Date	
Checked by VL	Date	The people behi
Approved by TDB	Date	TEL 604 420 1



Scale horiz. 1:250	Scale vert.	1:125
Sheet 02	of	02
Eng. Project No. 20-1027		

)	Project	BF
$\frac{25}{2}$		ΑT
2	Description	RC

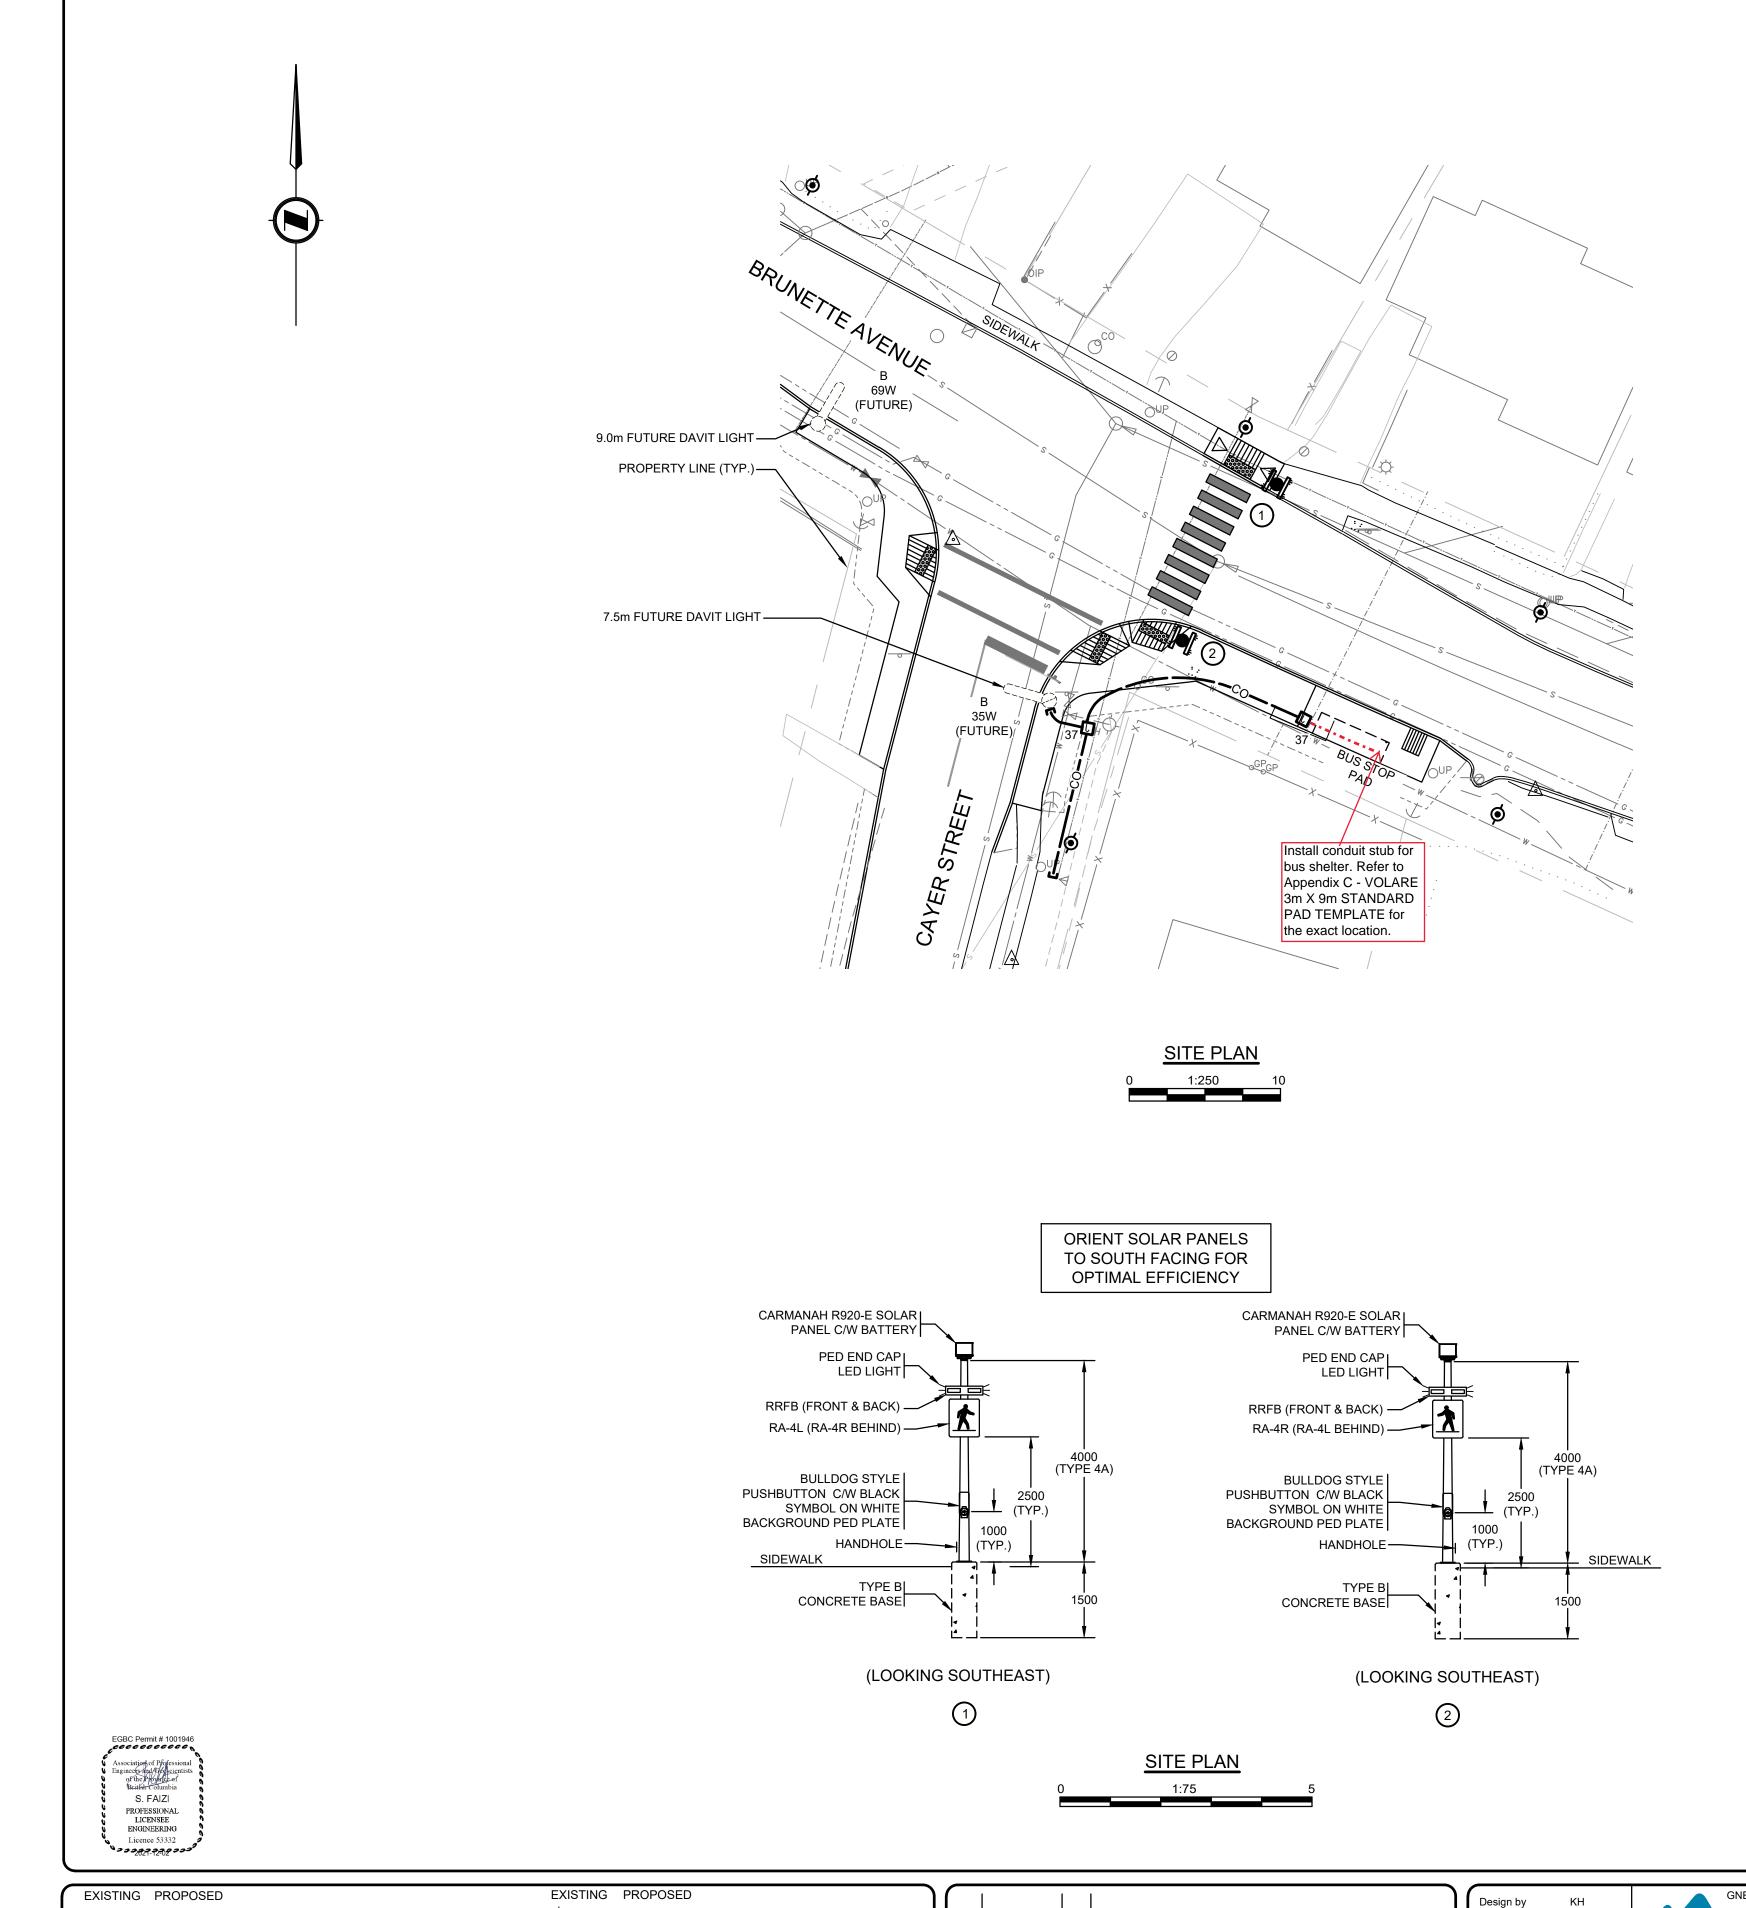

BC Hydro Pole c/w Rental Luminaire

Luminaire on Red or Black Phase Conductor

Junction Box (Type as noted on plan)

2 21-12-02 KH ISSUED FOR TENDER

0 21-05-13 KH FIRST SUBMISSION

No. Date By Revisions

1 21-08-27 KH DESIGN CHANGE TO SIDE MOUNTED RRFB

BC Hydro Pole

Type 4A Pole c/w RRFB Flashers and Pedestrian signs

Stub out & Run 35mm RPVC for Future Extension

(cap conduit leave pull string inside conduit)

35mm RPVC Empty Conduit

--·CO·**- --**·CO·**-**

NOTES:

- 1. UNLESS OTHERWISE INDICATED, ALL WORK SHALL BE DONE IN ACCORDANCE WITH THE MMCD 2009 PLATINUM EDITION AND THAT OF THE CITY OF COQUITLAM CURRENT SUBDIVISION CONTROL BYLAW AND MUST PASS THEIR INSPECTIONS. PLEASE CONTACT THE PROJECT COORDINATOR 72 HOURS PRIOR TO COMMENCING CONSTRUCTION.
- 2. CHECK BEFORE YOU DIG. THE CONTRACTOR SHALL REFER TO CIVIL "AS-BUILT" DRAWINGS FOR ALL UTILITIES, SERVICE LOCATIONS AND DETAILS. THE EXACT LOCATION OF THESE UTILITIES SHALL BE DETERMINED ON SITE.
- 3. PRIOR TO RRFB POLE BASE INSTALLATIONS, THE CONTRACTOR SHALL ENSURE THAT ALL POLES SHALL BE A MINIMUM OF 2.0m CLEAR OF ALL
- HYDRO POLES AND 3.0m CLEAR OF OVERHEAD PRIMARY WIRES, AND 1m CLEAR OF ALL OVERHEAD SECONDARY WIRES.

 4. THE CONTRACTOR SHALL NOTIFY PROVINCIAL AND MUNICIPAL INSPECTORS 24 HOURS PRIOR TO COMMENCEMENT OF UNDER GROUND AND
- 4. THE CONTRACTOR SHALL NOTIFY PROVINCIAL AND MUNICIPAL INSPECTORS 24 HOURS PRIOR TO COMMENCEMENT OF UNDER GROUND AND ELECTRICAL WORK.
- 5. THE CONTRACTOR SHALL OBTAIN ALL EQUIPMENT APPROVAL PERMITS FROM THE ELECTRICAL SAFETY BRANCH. THE ELECTRICAL SAFETY BRANCH SHALL BE MADE AWARE OF THE (POSSIBLE) USE OF AN IRRIGATION SYSTEM WITHIN THE STREET LIGHT POLES.
- 6. MINIMUM DEPTH FOR UNDER GROUND DUCTING SHALL BE 600mm BELOW BOULEVARD AND SIDEWALKS AND 900mm BENEATH ASPHALT, AND AS PER COQUITLAM STANDARD DRAWING E-5.
- 7. ALL POLES, ARMS, SERVICE BASES, ETC., ARE TO BE HOT DIP GALVANIZED, PRIMED AND POWDER COATED "COQUITLAM GREEN" RAL 6028 IN COLOUR
- 8. BONDING (GROUNDING) BOLT/BOLT-HOLE AREA INSIDE POLE TO BE MASKED BEFORE POWDER COATING TO LEAVE CLEAN GALVANIZED SURFACE FOR GOOD ELECTRICAL CONDUCTIVITY (OR REMOVE POWDER COATING IN THIS AREA AFTERWARDS)
- 9. ALL POLE HAND HOLE ACCESS SHALL BE GALVANIZED CAST STEEL COVER WITH REINFORCED BACKING PLATE. HAND HOLE SHALL UTILIZE NOVA POLE TAMPER PROOF FLOWER BOLT HEAD C/W REINFORCED TAMPER PROOF GALVANIZED BACKING BAR WITH TRANSVERSE ORITENTATION & LEFT HANDED THREAD.
- 10. EACH LUMINAIRE SHALL BE WIRED WITH No. 12 RW90. BLACK AND WHITE FOR 120V SERVICE, BLACK AND RED FOR 240V SERVICE.
- 11. EACH STREET LIGHT LUMINAIRE SHALL BE PROVIDED WITH TRON-HEBB-AA WATER PROOF FUSE HOLDER(S), C/W 2 TYPE "L" INSULATING BOOTS, OR APPROVED EQUIVALENT. EACH FUSE HOLDER SHALL BE PROVIDED WITH A 10-A BUSS KTK-TYPE FUSE, WIRED IN LIVE CONDUCTORS(S). FOR 240V SERVICES, ONE FUSE SHALL BE PROVIDED FOR EACH LIVE CONDUCTOR. THE FUSE HOLDER(S) SHALL BE ACCESSIBLE FROM THE HAND HOLE ACCESS AT THE POLE BASE.
- 12. ALL LUMINAIRES SHALL BE BONDED WITH A NUMBER 12 RW90 CONDUCTOR (GREEN). THE CONTRACTOR SHALL SUPPLY A PIGTAIL SPLICE WITH A RING LUG TERMINAL FOR THE BOND STUD.
- 13. THE BONDING STUD IN EACH POLE SHALL COMPRISE OF ONE 3/8-16 BOLT, 2.0 INCHES LONG, ONE SPLIT LOCK WASHER, AND TWO HEX NUTS. THE SPLIT LOCK-WASHER SHALL BE SLID ONTO THE BOLT ON THE INSIDE OF THE POLE, AND HELD TIGHTLY IN PLACE WITH THE FIRST NUT. THIS NUT SHALL BE TIGHTENED TO SPECIFICATION. THE RING TERMINAL SHALL BE SANDWICHED BETWEEN THE TWO HEX NUTS. THE LAST NUT HOLDS THE RING TERMINAL IN PLACE. THIS NUT SHALL BE TIGHTENED TO SPECIFICATIONS. THE POLE MANUFACTURER/CONTRACTOR SHALL ENSURE THE AREA AROUND THE BONDING NUT ON THE INSIDE OF THE POLE IS PAINT FREE TO OBTAIN A SOLID MECHANICAL AND ELECTRICAL BOND CONNECTION.
- 14. ALL POLES SHALL BE BONDED WITH A No. 8 RW90 CONDUCTOR (GREEN). THE CONTRACTOR SHALL SUPPLY A PIGTAIL SPLICE WITH RING LUG
- 15. ALL UNDERGROUND AND IN-POLE SPLICES SHALL BE FULLY SEALED WITH TAPE CONSISTING OF BISHOP BI-SEAL, PHILLIPS ROTUNDRA OR 3M SELF-HOLDING TAPE; COVERED WITH PVC TAPE AND DIPPED IN 3M SCOTCHCOAT, OR APPROVED EQUIVALENT.
- 16. EMPTY CONDUITS / CONDUITS ONLY (CO) SHALL BE PROVIDED WITH A NYLON PULL LINE, AND EACH END SHALL BE CAPPED.
- 17. STANDING WATER IS NOT PERMITTED IN CONDUITS. CONDUITS WITH WATER SHALL BE BLOWN CLEAR OF WATER.
- 18. ALL CONDUCTORS SHALL BE STRANDED, COPPER, RW90 SIZES PER PLANS.19. STREET LIGHT POLES SHALL BE WIRED PER MMCD 2009 PLATINUM EDITION PLAN E7.11.
- 20. ALL CONCRETE BASES SHALL HAVE A V-GROOVE TO DRAIN WATER. ENSURE THE V-GROVE IS FREE OF CONCRETE SLAG.
- 21. ALL CONCRETE BASES SHALL BE LEVEL ON 2 AXIS.

THIS DRAWING AND ALL RELATED FILES ARE PROPRIETARY TO GNEC. RESPONSIBILITY CANNOT BE ACCEPTED BY GNEC FOR ALTERATION AND/OR DEVIATION FROM THIS DESIGN WITHOUT PRIOR ACCEPTANCE BY GNEC. ALL WORK SHOWN IS TO BE CONDUCTED TO THE SATISFACTION OF THE ENGINEER OF RECORD.

THIS DRAWING IS TO BE READ IN CONJUNCTION WITH ALL OTHER RELEVANT PROJECT DRAWINGS, SPECIFICATIONS, AND DOCUMENTATION. ALL EXISTING CONDITIONS SHOWN ARE TO BE VERIFIED BY THE CONTRACTOR ON SITE, AND ANY DISCREPANCIES REPORTED TO GNEC FOR ADJUSTMENT AND DIRECTION.

FIELD LAYOUT TO BE CONFIRMED WITH ENGINEER PRIOR TO CONSTRUCTION

IN THE EVENT OF ANY UTILITY CONFLICTS THE CONTRACTOR SHALL CONTACT GREAT NORTHERN
ENGINEERING AT 1-855-463-2266
3 WORKING DAYS PRIOR TO PLANNED INSTALLATION

3 WORKING DAYS PRIOR TO PLANNED INSTALLATION
TO ARRANGE FOR THE ENGINEER TO HELP RESOLVE ANY CONFLICTS AND PROVIDE DIRECTION



CHECK BEFORE YOU DIG

AN APPROXIMATE WAY ONLY AND HAVE NOT BEEN INDEPENDENTLY VERIFIED BY THE OWNER OR ITS REPRESENTATIVE. SOME UTILITIES MAY NOT BE SHOWN. THE CONTRACTOR SHALL DETERMINE THE EXISTENCE AND EXACT LOCATION OF ALL EXISTING UTILITIES BEFORE COMMENCING WORK AND AGREES TO BE FULLY RESPONSIBLE FOR ANY AND ALL DAMAGES WHICH OCCUR DUE TO THE CONTRACTOR'S FAILURE TO EXACTLY LOCATE AND PRESERVE ANY AND ALL EXISTING UTILITIES.



ACCEPTED FOR

CONSTRUCTION

Development Servicing

Manager of

Great Northern Engineering Consultants

202 - 8525 Baxter Place

Burnaby, BC V5A 4V7

Phone: 1-855-463-2266

www.gnec.ca

Drawn by

Checked by

Approved by

Coouitlam

Engineering & Public Works

3000 Guildford Way, Coquitlam, B.C. V3B 7N2

NOT FOR CONSTRUCTION

ALL EQUIPMENT IS PROPOSED

Scale horiz.	Scale vert.
Sheet of	1 of 1
Eng. Project No.	TBD

BRUNETTE AVENUE AT CAYER STREET - RRFB

RRFB - SITE PLAN AND DETAILS

File: 21BC-0030 - Coquitlam - Cayer St RRFB