"Civic Address," Coquitlam, BC - TRIPLEX 1



1) 3D View 1 - Option B

FLOOR AREA (m2)					
Unit #	Level	Name	Area		
1	LEVEL 1	RESIDENTIAL	79.91 m²		
1	LEVEL 2	RESIDENTIAL	79.91 m²		
			159.81 m²		
2	LEVEL 1	RESIDENTIAL	77.25 m²		
2	LEVEL 2	RESIDENTIAL	77.33 m²		
			154.58 m ²		
3	LEVEL 1	RESIDENTIAL	87.75 m²		
3	LEVEL 2	RESIDENTIAL	83.03 m ²		
			170.77 m²		
TOTAL PR	OPOSED FLO	OR AREA:	485.16 m ²		

OUTDOOR SPACE AREA				
Unit #	Level	Name	Area	
1	LEVEL 1	OUTDOOR PRIVATE SPACE	29.94 m	
1	LEVEL 2	BALCONY	7.15 m	
			37.09 m	
2	LEVEL 1	OUTDOOR PRIVATE SPACE	32.47 m	
2	LEVEL 2	BALCONY	7.15 m	
	•		39.63 m	
3	LEVEL 1	OUTDOOR PRIVATE SPACE	57.28 m	
3	LEVEL 2	BALCONY	5.99 m	
			63.27 m	

STATISTICS Civic Address:

Coquitlam, BC _

Legal Address:

Current Zoning: RT-1

Proposed Use:

Existing Lot Area:

Dedicated Lot Area:

Net Lot Area: ____m²

DRAWING LIST - OPTION B				
SHEET NUMBER SHEET NAME				
A002	STATISTICS			
A100	SITE PLAN			
A120	LEVEL 1 PLAN			
A130	LEVEL 2 PLAN			
A140	ROOF PLAN			
A200b	ELEVATIONS - OPTION B			
A201b	ELEVATIONS - OPTION B			
A205	SPATIAL SEPARATION CALCULATIONS			
A300	SECTIONS			
A305	RETAINING WALL SECTIONS			
A500	DETAILS			
A600b	3D VIEWS - OPTION B			
A601b	3D VIEWS - OPTION B			
A602b	3D VIEWS - OPTION B			
A900	AREA PLANS			
Grand total: 15				

DEVELOPMENT DATA SUMMARY

LOT COVERAGE:

Maximum Permitted Lot Coverage: 50%

Proposed Lot Coverage: Area Covered by Building: ___m² / Net Lot Area ___m² = ___m²

TOTAL FLOOR AREA:

Maximum Permitted: 0.75 x Lot Area =

Proposed:

_ m² / Existing Lot Area ___m² = ___FSR

PRIVATE OUTDOOR AMENITY SPACE:

Minimum Required:

37 m² per unit

Minimum Required:

From Front Property Line = 5.5m From Rear Property Line = 6.0m Interior Side Property Line = 1.2m Exterior Side Property Line = 3.0m

From Front Property Line = 5.5m From Rear Property Line = 6.0m Interior Side Property Line = 1.2m Exterior Side Property Line = n/a

HEIGHT:

Maximum Permitted:

(ii) 11.0 metres for buildings and structures having a roof slope with a pitch of 3 in 12 or greater for an area of at least 80% of all roof surfaces.

Proposed Height:Lowest of either Natural grade or Finished grade at the building corners: Northwest corner = elevation ____ metres Southwest corner = elevation ____ metres Northeast corner = elevation

Southeast corner = elevation metres Sum of all Elevations = Total = elevation

<u>Divide Total Elevation by 4 = Average Grade</u> = elevation _ Top of Roof Peak Elevation = Top of Roof Peak Elevation = _____ metres
Height = Difference between Average Grade and Roof Peak Elevation = elevation

____ metres

Garbage and Organic Waste:

Minimum Required:

Two carts per unit each. Cart measures 0.74 m front to back, 0.58 m side to side, and a height of 1.07 m.

Garbage room for 2 carts measuring 1.31 m x 0.85 m internal per unit.

VEHICLE PARKING:

Minimum Required:

2 spaces per dwelling unit, of which a Fourplex Residential:

maximum of 100% may be tandem parking spaces

Total:

= 6 parking spaces

Provided:

6 parking spaces

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TRIPLEX 1

Issue Date: (YYYY-MM-DD) Drawn Project Number: Revision Date


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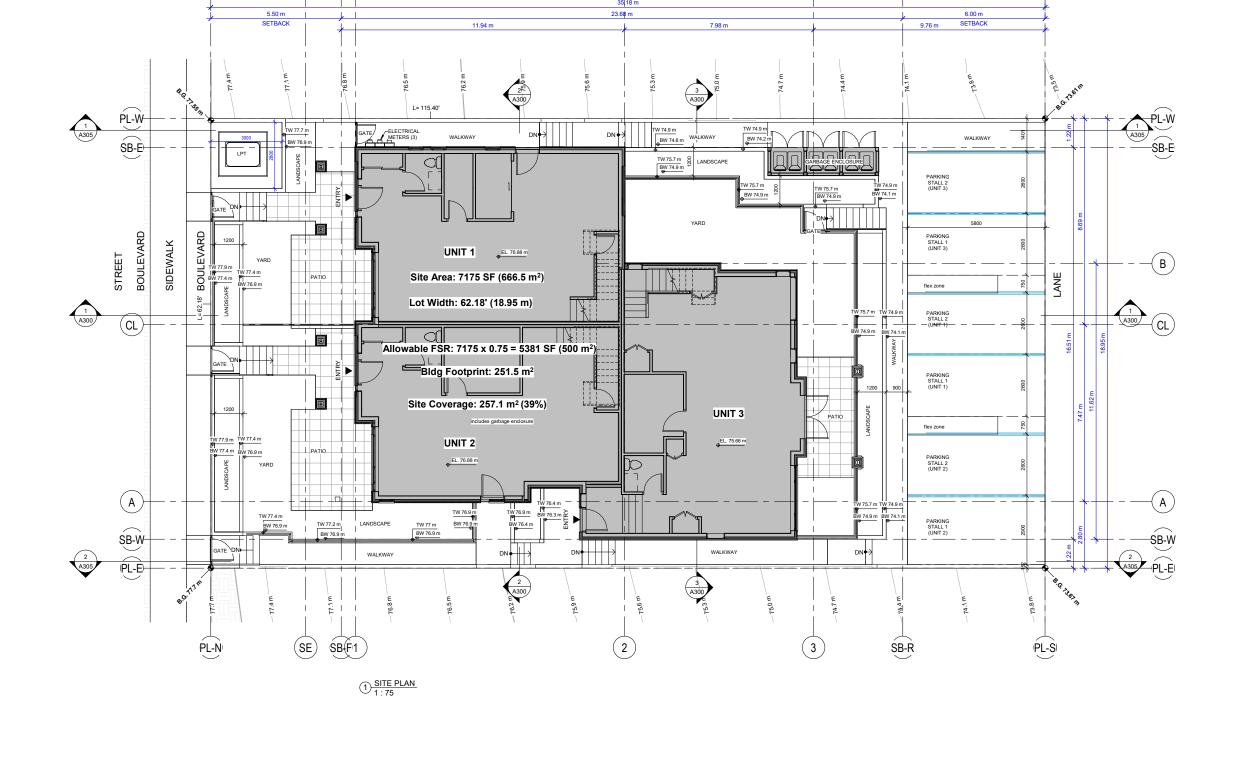
STATISTICS

1 1/2" = 1'-0"

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A002



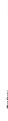

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Project: TRIPLEX 1

PL-N

(SE)

SB(F1

Issue Dat

Issue Date: (YYYY-MM-DD) Drawn: Checked:
- -
Revision Date: Project Number:

Drawing:
SITE PLAN
Scale:

1:75



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PL-S

SB-R

 1645 West 5th Avenue
 Tel: 604-872-2595

 Vancouver, BC V6J 1N5
 Email: office@amarchitects.com

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TRIPLEX 1

Issue Date: (YYYY-MM-DD) Revision Date:

Drawn Checked: Project Number:

Drawing: **LEVEL 1 PLAN** Scale:

1:50

ap dig

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1645 West 5th Avenue Vancouver, BC V6J 1N5 Tel: 604-872-2595 Email: office@amarchitects.com

A120

Date: 272-102-13 West 1023-48 DAIDT BEVIT I DCAL FILESNOW OF MAIN P20 OF SN

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TRIPLEX 1

Issue Date: (YYYY-MM-D
Revision Date:

Drawn: Checked:
- - Project Number:

Drawing:

LEVEL 2 PLAN

Scale:

1:50




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A130







PL-W

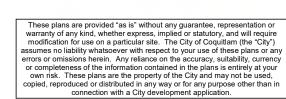
(11)

271.23' LEVEL 3

262.23' LEVEL 2

252.23' LEVEL 1

SB-È

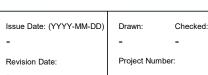






1645 West 5th Avenue Vancouver, BC V6J 1N5 Email: office@amarchitects.com

INTERLOCKING BLOCK RETAINING WALL, COLOUR: NATURAL STONE GRAY STUCCO, LIGHT DASH, PAINTED, COLOUR: Benjamin Moore Kingsport Gray HC-86 STUCCO, LIGHT DASH, PAINTED, COLOUR: Benjamin Moore Pale Oak OC-20 STUCCO, LIGHT DASH, PAINTED, COLOUR: Benjamin Moore Oxford White CC-30 --and-- SOFFIT, NATURAL STAINED CEDAR OR FIBER CEMENT TRUESOFFIT (6.25" EXPOSURE), FINISH: TRUE GRAIN SERIES, COLOUR: CEDARTONE FIBER CEMENT LAP SIDING (4" EXPOSURE) & FIBER CEMENT TRUESOFFIT (6.25" EXPOSURE), FINISH: TRUE GRAIN SERIES, COLOUR: CEDARTONE FIBER CEMENT LAP SIDING (4" EXPOSURE) & FIBER CEMENT TRUESOFFIT (6.25" EXPOSURE), FINISH: TRUE GRAIN SERIES, COLOUR: NIGHT RIDER FIBER CEMENT LAP SIDING (4" EXPOSURE), FINISH: TRUE GRAIN SERIES, COLOUR: WEST COAST GREY FIBER CEMENT LAP SIDING (4" EXPOSURE), FINISH: SMOOTH, COLOUR: Sherwin Williams Searching Blue SW-6536 STONE VENEER, UP TO 1 1/2" THICK, COMPLETE WITH LINEAR COPING STONE, STONE SHAPE: MODERN LINEAR ASHLAR, COLOUR: WHITE / LIGHT GREY: LIMESTONE or SAND or BASALT or VERSETTA ALUMINUM FLASHING, 2 1/2" EXPOSURE, COLOUR: STANDARD SILVER (TO MATCH WINDOWS) ALUMINUM WINDOWS, FRAME COLOUR: STANDARD SILVER PATIO DOOR, PREFINISHED ALUMINUM, HIGH EFFICIENCY, DOUBLE GLAZED, MULLION AND DOOR COLOUR: UNIT ENTRANCE DOOR, PREFINISHED ALUMINUM, HIGH EFFICIENCY, DOUBLE GLAZED, MULLION AND DOOR COLOUR: STANDARD SILVER METAL LOCKING DOOR (GARBAGE), COLOUR: Benjamin Moore Kingsport Gray HC-86 RAILING, POWDER COATED ALUMINUM, CLEAR GLASS PANEL, COLOUR: STANDARD SILVER RAILING - ALUMINUM PICKET, COLOUR: STANDARD SILVER ROOF, ASPHALT SHINGLES, COLOUR: MEDIUM GRAY FASCIA BOARD / COLUMN / DECK EDGE, COLOUR: SILVER (OR SIMILAR) ALUMINUM GUTTER - COLOUR: STANDARD SILVER

MATERIAL LEGEND

EXPOSED ARCHITECTURAL CAST-IN-PLACE CONCRETE WALL / PEDESTAL / STAIR / RAMP / PLANTER

Material

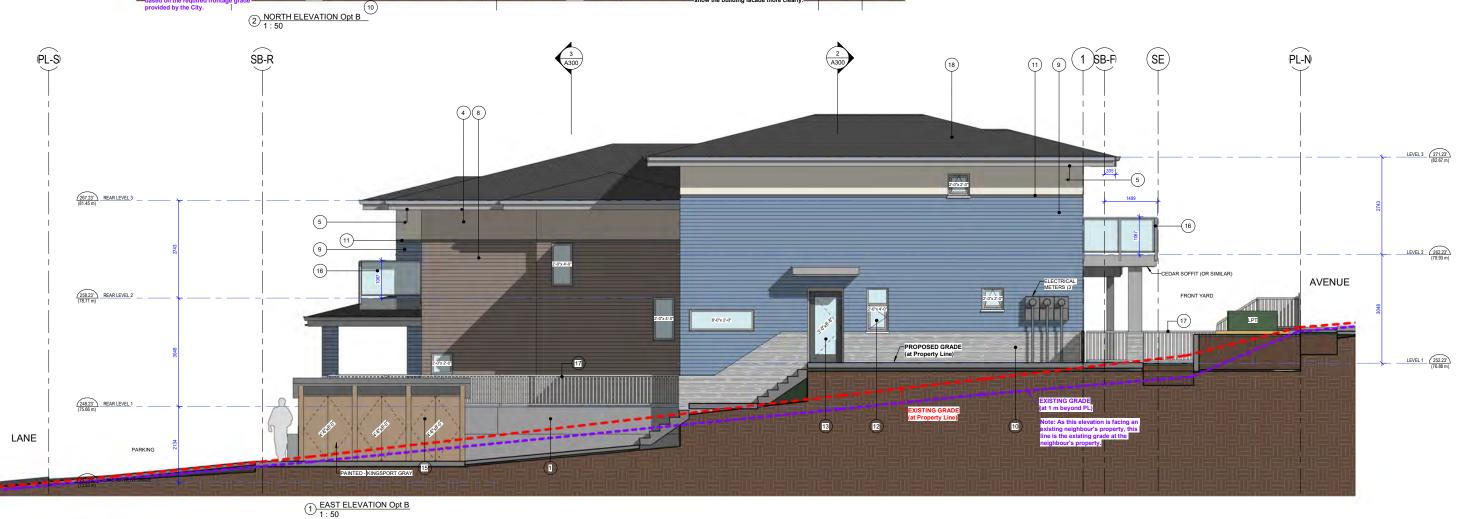



SB-W

PL-E

Number

A200b

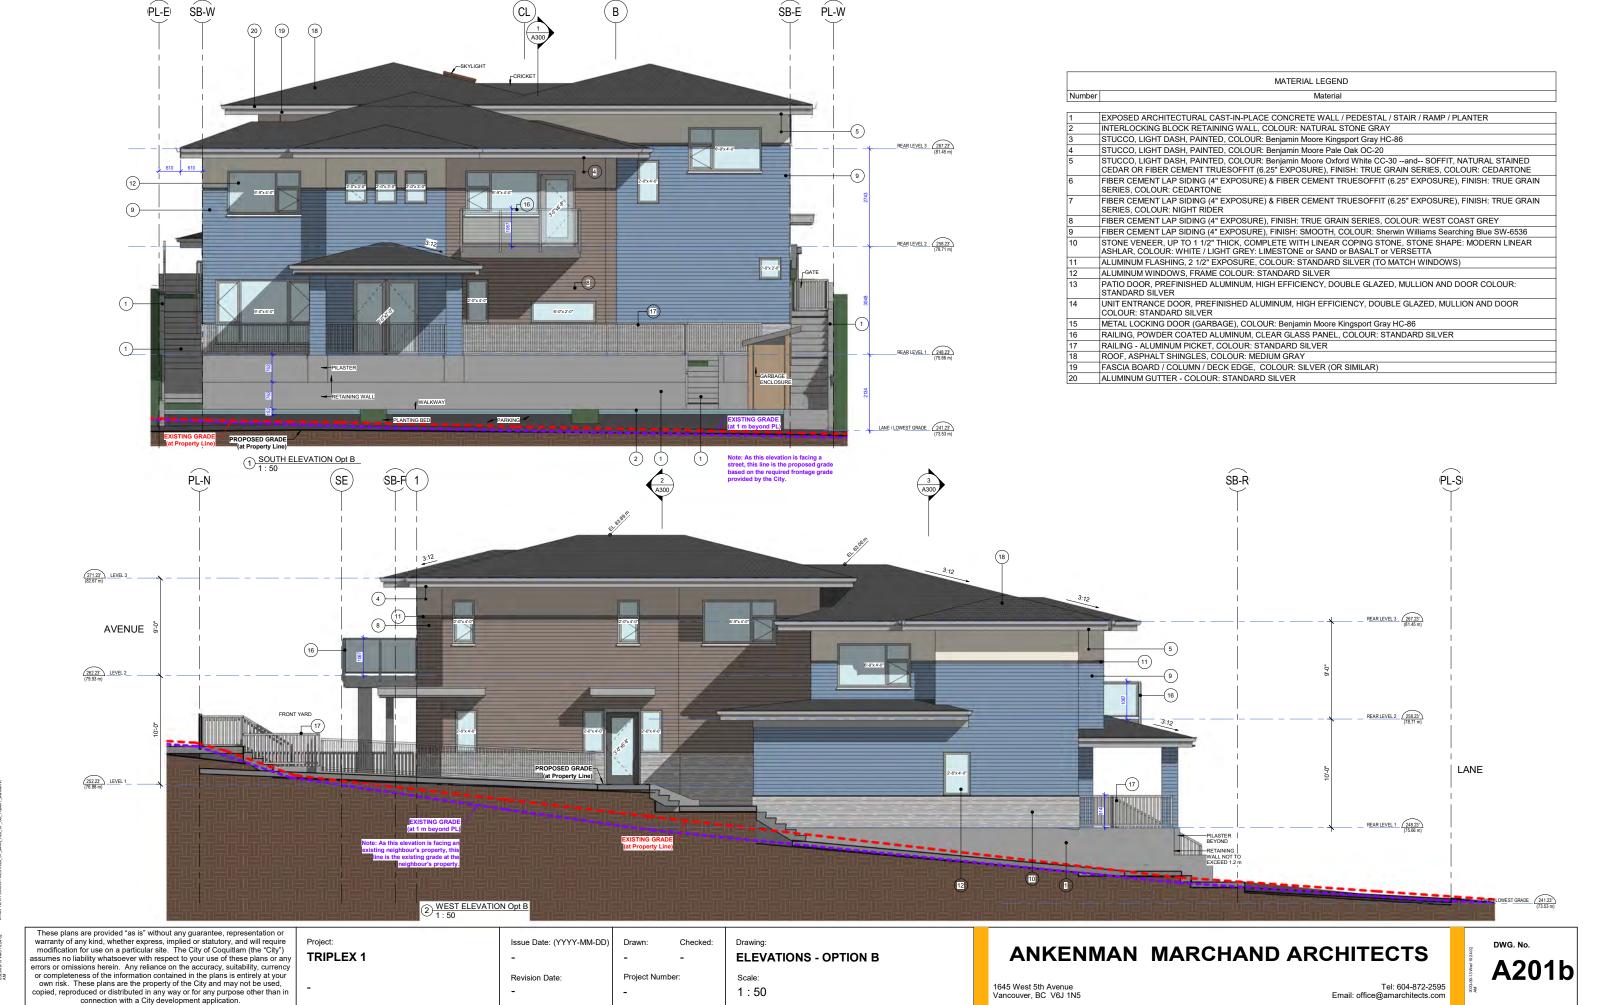

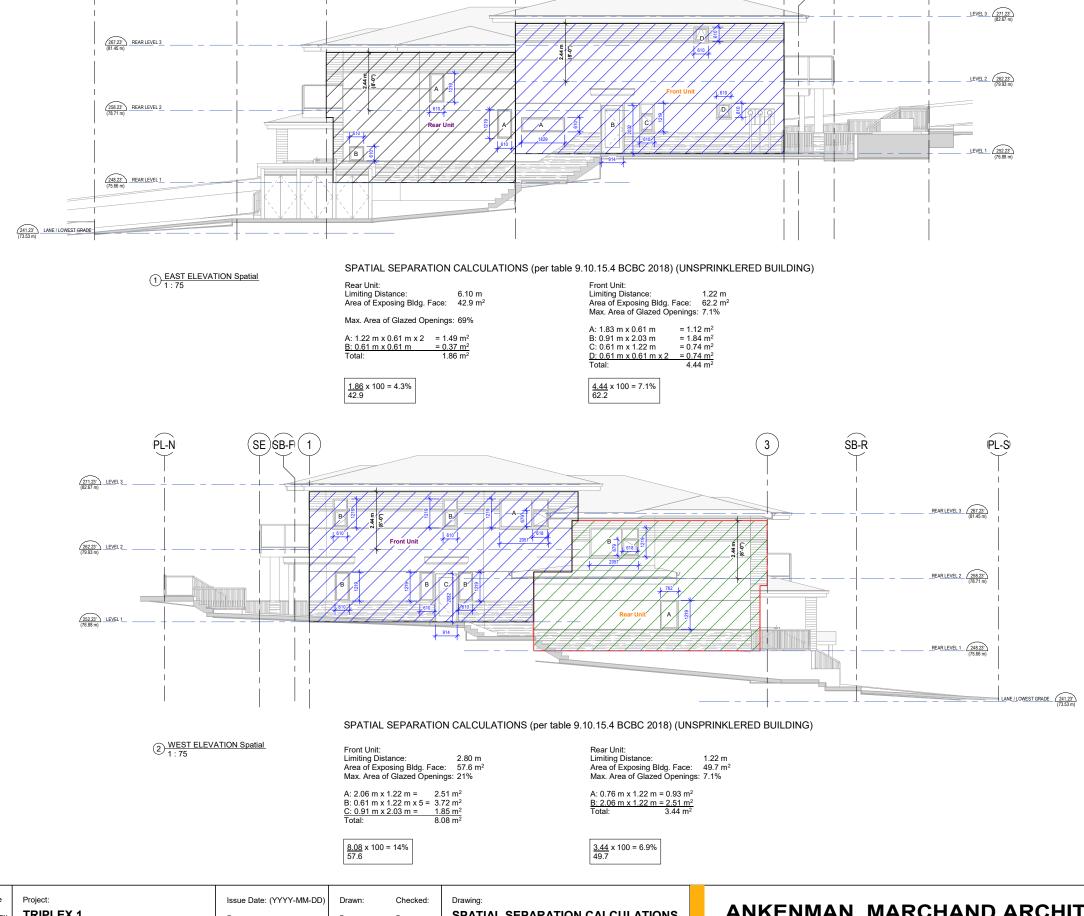

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TRIPLEX 1

PL-S

ŚB-R

(3)

Revision Date

Project Number:

1:75

SPATIAL SEPARATION CALCULATIONS


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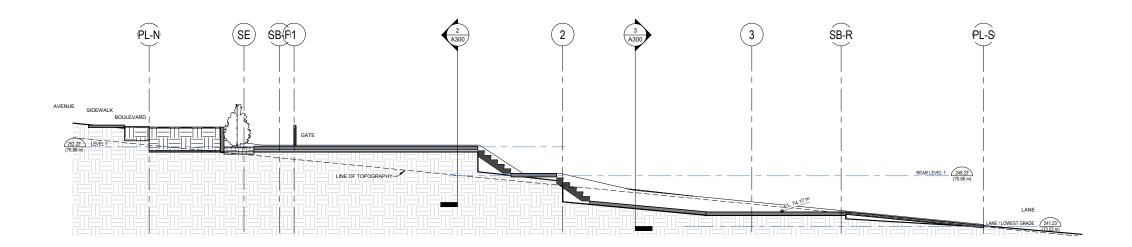
1645 West 5th Avenue Vancouver, BC V6J 1N5

1)SB-F(SE)


PL-N

Tel: 604-872-2595 Email: office@amarchitects.com



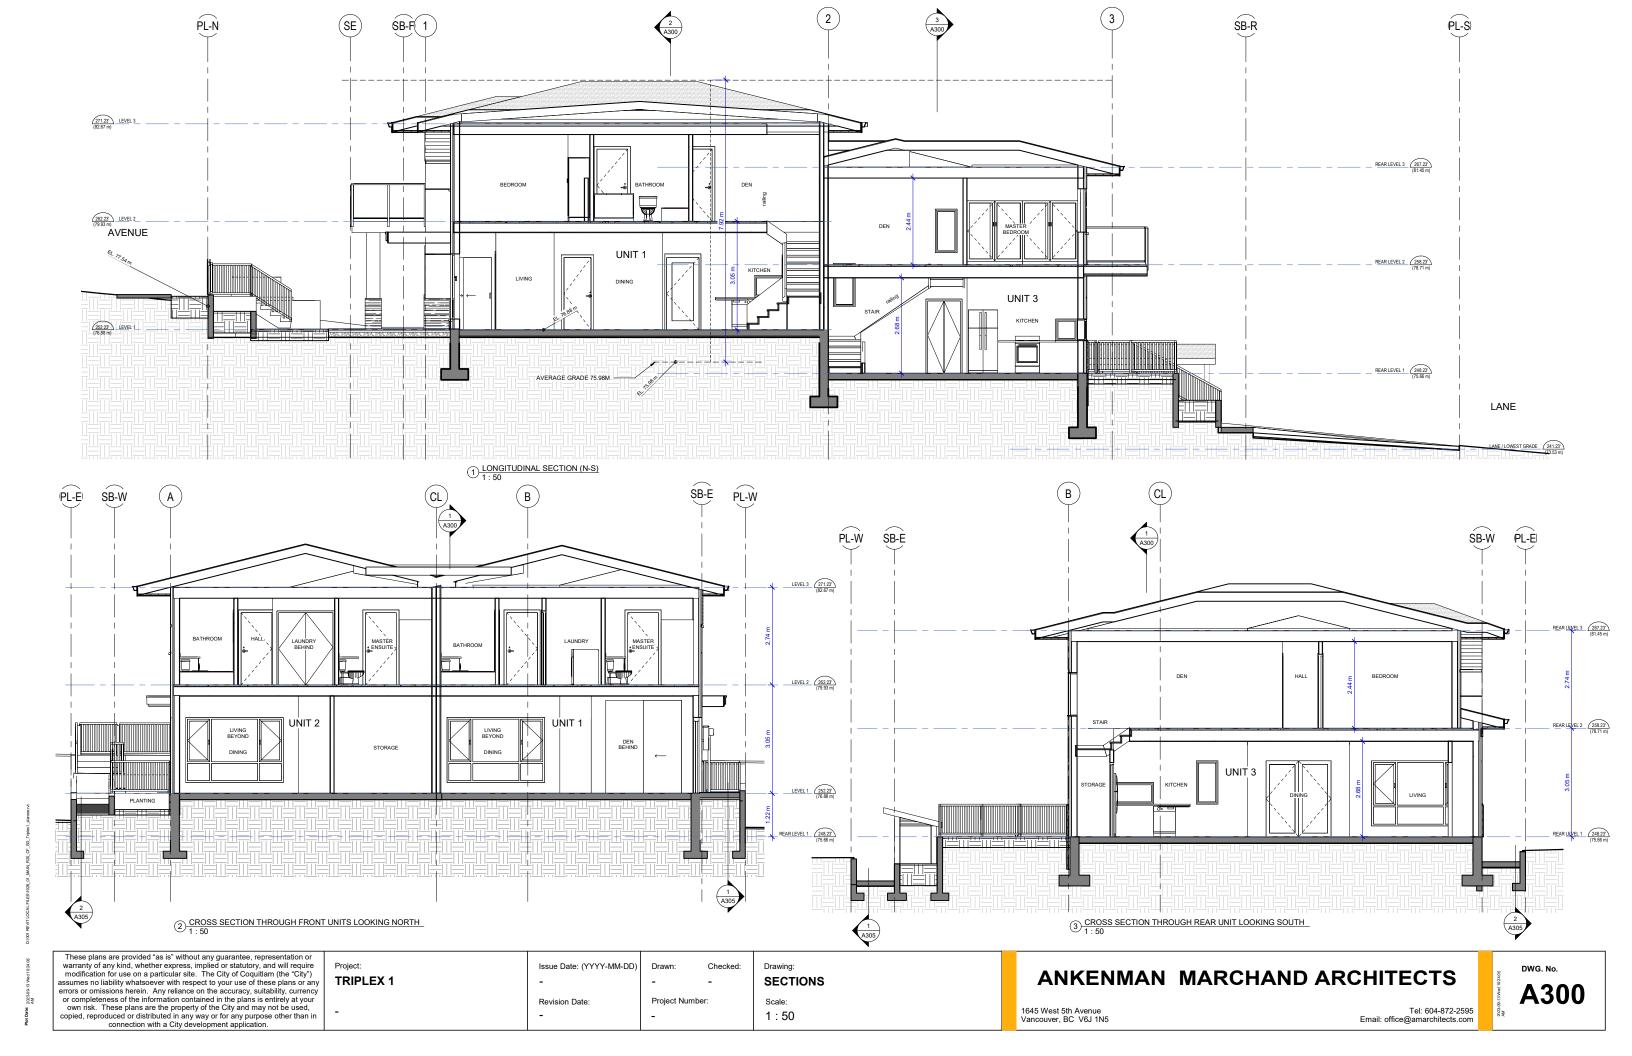

1 EAST LONGITUDINAL SECTION LOOKING AT NEIGHBOUR 1:75

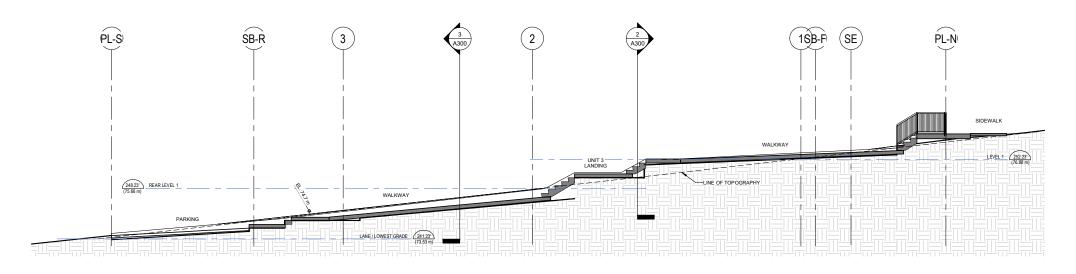

 $\textcircled{2} \frac{\text{WEST LONGITUDINAL SECTION LOOKING AT NEIGHBOUR}}{1:75}$

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Project: **TRIPLEX 1** Issue Date: (YYYY-MM-DD) Revision Date:

Drawn: Checked: Project Number:


RETAINING WALL SECTIONS


1:75

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A305



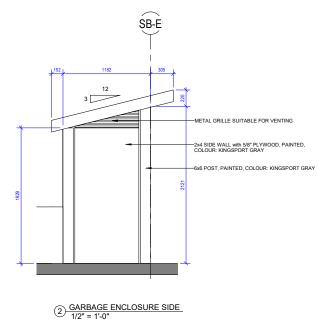

Wildlife Resistant Enclosures

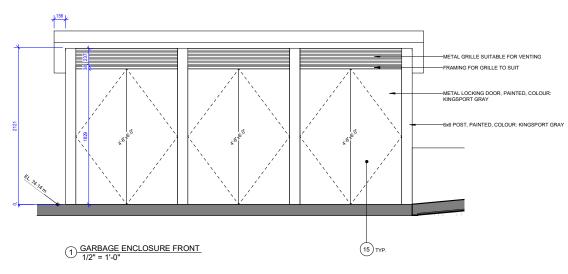The wildlife resistant enclosure is used to secure solid waste and prevent wildlife from accessing attractants. Enclosures should be strong enough to withstand the weight and strength of a 600-pound animal.

Wildlife enclosures can include heavy-duty sheds, chain link fencing or prefabricated metal storage lockers/containers. A wildlife resistant enclosure is defined in the Solid Waste Management Bylaw No. 4679, 2016 as "a fully enclosed structure consisting of wall, roof, and door of sufficient design and strength so as to be capable of keeping its contents inaccessible to wildlife."

When choosing a wildlife resistant enclosure, consider the following:

- Hinges and latches should be strong enough that they cannot be pried open by claws, and the trigger on the latch should be inaccessible to wildlife. Mount heavy duty hinges to the inside of the enclosure.
- The material should be strong enough that wildlife cannot bite through, bend or crush the enclosure.
- Wooden enclosures should use plywood that is at least 5/8" thick, 2x4 construction, and screws instead of
- There should be no seams that claws can get into. Seams can be covered with metal flashing. Enclosures should be designed without any overhangs that claws can grab.
- The enclosure should be anchored to a stationary base to prevent tipping.
- The enclosure should have a roof/lid.

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Project: Issue Date: (YYYY-MM-DD) Drawing: Drawn Checked: **TRIPLEX 1 DETAILS** Project Number: Revision Date: 03/22/11 1/2" = 1'-0"

	MATERIAL LEGEND
Number	Material

1	EXPOSED ARCHITECTURAL CAST-IN-PLACE CONCRETE WALL / PEDESTAL / STAIR / RAMP / PLANTER
2	INTERLOCKING BLOCK RETAINING WALL, COLOUR: NATURAL STONE GRAY
3	STUCCO, LIGHT DASH, PAINTED, COLOUR: Benjamin Moore Kingsport Gray HC-86
4	STUCCO, LIGHT DASH, PAINTED, COLOUR: Benjamin Moore Pale Oak OC-20
5	STUCCO, LIGHT DASH, PAINTED, COLOUR: Benjamin Moore Oxford White CC-30and SOFFIT, NATURAL STAINED CEDAR OR FIBER CEMENT TRUESOFFIT (6.25" EXPOSURE), FINISH: TRUE GRAIN SERIES, COLOUR: CEDARTONE
6	FIBER CEMENT LAP SIDING (4" EXPOSURE) & FIBER CEMENT TRUESOFFIT (6.25" EXPOSURE), FINISH: TRUE GRAIN SERIES, COLOUR: CEDARTONE
7	FIBER CEMENT LAP SIDING (4" EXPOSURE) & FIBER CEMENT TRUESOFFIT (6.25" EXPOSURE), FINISH: TRUE GRAIN SERIES, COLOUR: NIGHT RIDER
8	FIBER CEMENT LAP SIDING (4" EXPOSURE), FINISH: TRUE GRAIN SERIES, COLOUR: WEST COAST GREY
9	FIBER CEMENT LAP SIDING (4" EXPOSURE), FINISH: SMOOTH, COLOUR: Sherwin Williams Searching Blue SW-6536
10	STONE VENEER, UP TO 1 1/2" THICK, COMPLETE WITH LINEAR COPING STONE, STONE SHAPE: MODERN LINEAR ASHLAR, COLOUR: WHITE / LIGHT GREY: LIMESTONE or SAND or BASALT or VERSETTA
11	ALUMINUM FLASHING, 2 1/2" EXPOSURE, COLOUR: STANDARD SILVER (TO MATCH WINDOWS)
12	ALUMINUM WINDOWS, FRAME COLOUR: STANDARD SILVER
13	PATIO DOOR, PREFINISHED ALUMINUM, HIGH EFFICIENCY, DOUBLE GLAZED, MULLION AND DOOR COLOUR: STANDARD SILVER
14	UNIT ENTRANCE DOOR, PREFINISHED ALUMINUM, HIGH EFFICIENCY, DOUBLE GLAZED, MULLION AND DOOR COLOUR: STANDARD SILVER
15	METAL LOCKING DOOR (GARBAGE), COLOUR: Benjamin Moore Kingsport Gray HC-86
16	RAILING, POWDER COATED ALUMINUM, CLEAR GLASS PANEL, COLOUR: STANDARD SILVER
17	RAILING - ALUMINUM PICKET, COLOUR: STANDARD SILVER
18	ROOF, ASPHALT SHINGLES, COLOUR: MEDIUM GRAY

FASCIA BOARD / COLUMN / DECK EDGE, COLOUR: SILVER (OR SIMILAR)


ALUMINUM GUTTER - COLOUR: STANDARD SILVER

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2 3D View 3 Opt B



1 3D View2 Opt B

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Project:

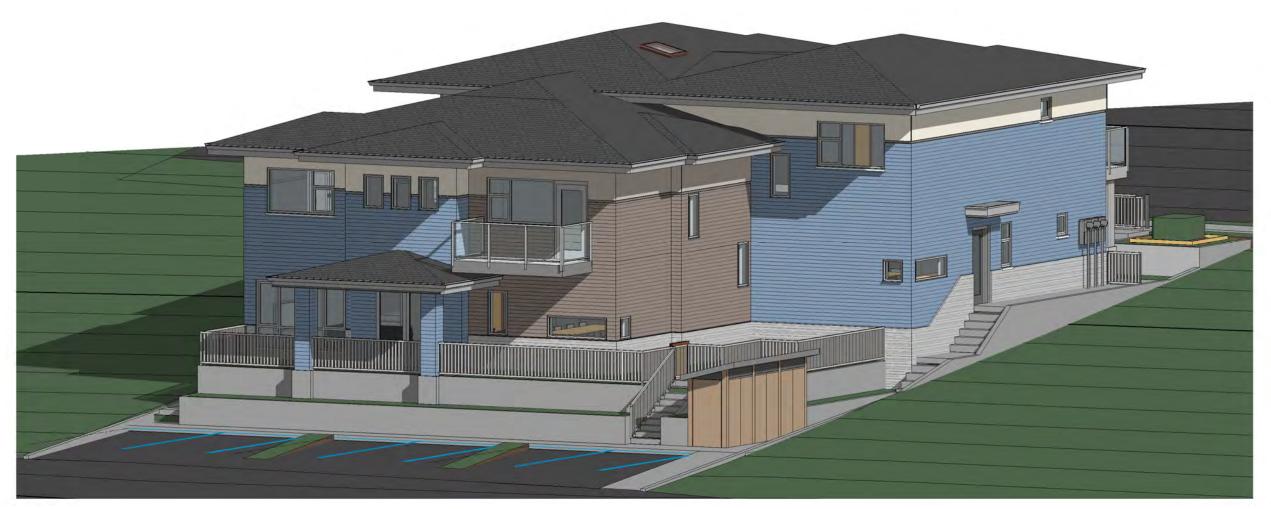TRIPLEX 1

Issue Date: (YYYY-MM-DD)

Revision Date:

Drawn:

Drawing: Checked: Project Number:

3D VIEWS - OPTION B

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A600b Tel: 604-872-2595 Email: office@amarchitects.com





(2) FRONT PERSPECTIVE Opt B





1 FRONT PERSPECTIVE 2 Opt B 3 REAR PERSPECTIVE 2 Opt B

Revision Date:

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Project: **TRIPLEX 1**

Issue Date: (YYYY-MM-DD)

Drawn:

Checked: Project Number:

3D VIEWS - OPTION B


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A601b Tel: 604-872-2595 Email: office@amarchitects.com







Project:

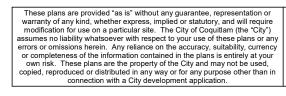Issue Date: (YYYY-MM-DD) **TRIPLEX 1**

Revision Date:

Drawn: Checked: Project Number:

Drawing: 3D VIEWS - OPTION B

1645 West 5th Avenue Vancouver, BC V6J 1N5




1 3D View 9 Opt B

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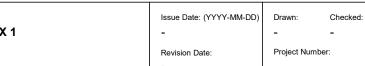
2 3D View 10 Opt B





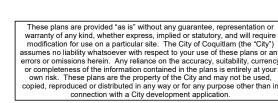

1 <u>LEVEL 1</u> 1:100



OUTDOOR PRIVATE SPACE





2 LEVEL 2 1 : 100

BALCONY UNIT3 5.99 m²

Area Legend

BALCONY

RESIDENTIAL

(CL)

PL-ESB-W (A)

PL-N

2

SB-R-

PL-S

Scale:


(B)

BALCONY UNIT1 7.15 m²

RESIDENTIAL UNIT1 79.91 m²

ŚB-ÈPL-W

SE

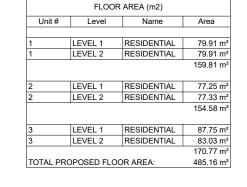

RESIDENTIAL GROSS FLOOR AREA (SF)						
Unit # Level Name Area						
1	LEVEL 1	RESIDENTIAL	860 SF			
1	LEVEL 2	RESIDENTIAL	860 SF			
			1720 SF			
2	LEVEL 1	RESIDENTIAL	831 SF			
2	LEVEL 2	RESIDENTIAL	832 SF			
1664 SF						
3	LEVEL 1	RESIDENTIAL	944 SF			
3	LEVEL 2	RESIDENTIAL	894 SF			
	•		1838 SF			
TOTAL PROPOSED FLOOR AREA: 5222 SF						

		OUTDOOR SPACE AREA	
Unit #	Level	Name	Area
1	LEVEL 1	OUTDOOR PRIVATE SPACE	29.94
1	LEVEL 2	BALCONY	7.15
	•		37.09
2	LEVEL 1	OUTDOOR PRIVATE SPACE	32.47
2	LEVEL 2	BALCONY	7.15
	•		39.63
3	LEVEL 1	OUTDOOR PRIVATE SPACE	57.28
3	LEVEL 2	BALCONY	5.99
	•		63.27



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DWG. No. A900

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Area Legend

RESIDENTIAL

(CL)

PL-ESB-W (A

OUTDOOR PRIVATE SPACE
UNIT2
32.47 m²

RESIDENTIAL UNIT2 77.25 m²

RESIDENTIAL UNIT3 87.75 m²

PL-N-

SB-F

2

(3)

SB-R


PL-S

B

SB-EPL-W

LPT

SE

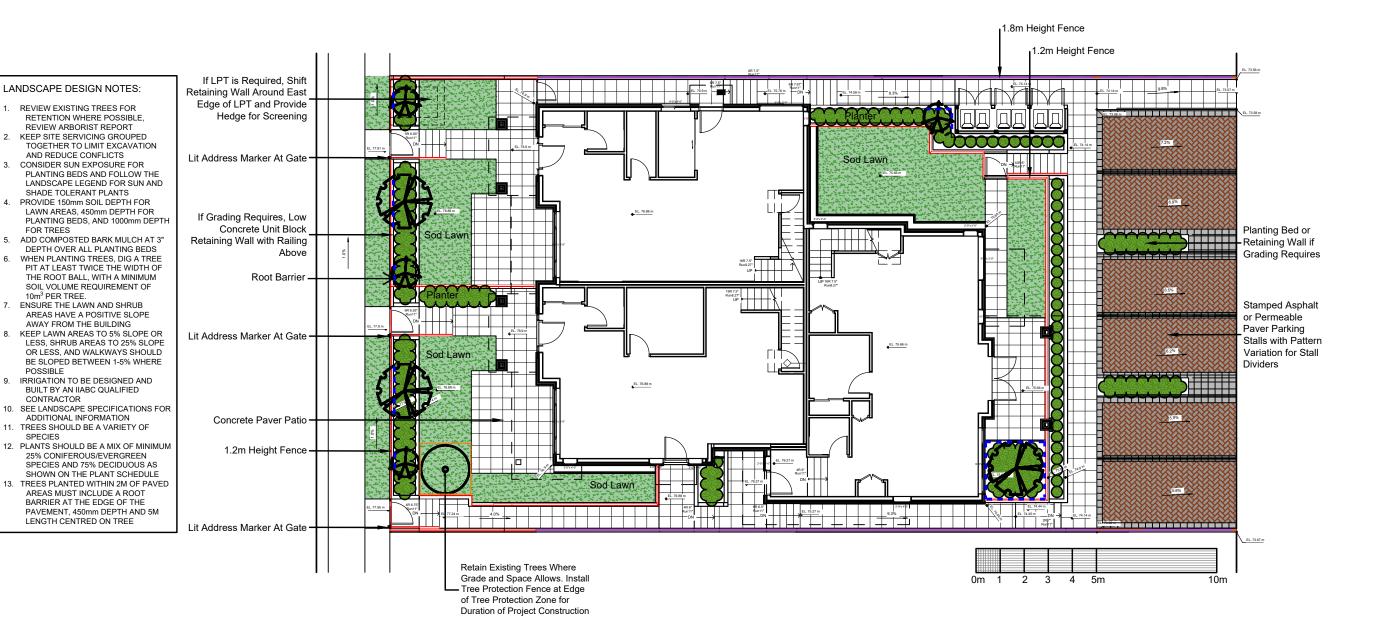

Suite C100 - 4185 Still Creek Drive Burnaby, British Columbia, V5C 6G p: 604 294-0011; f: 604 294-0022

FOR TREES

10m³ PER TREE.

POSSIBLE

SPECIES

CONTRACTOR

CLIENT: CITY OF COQUITLAM

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TRIPLEX

LANDSCAPE PLAN

DRAWING TITLE:


SCALE: 1:200 DRAWN:

21-058

21058-Triplex-3.ZIP

LEGEND



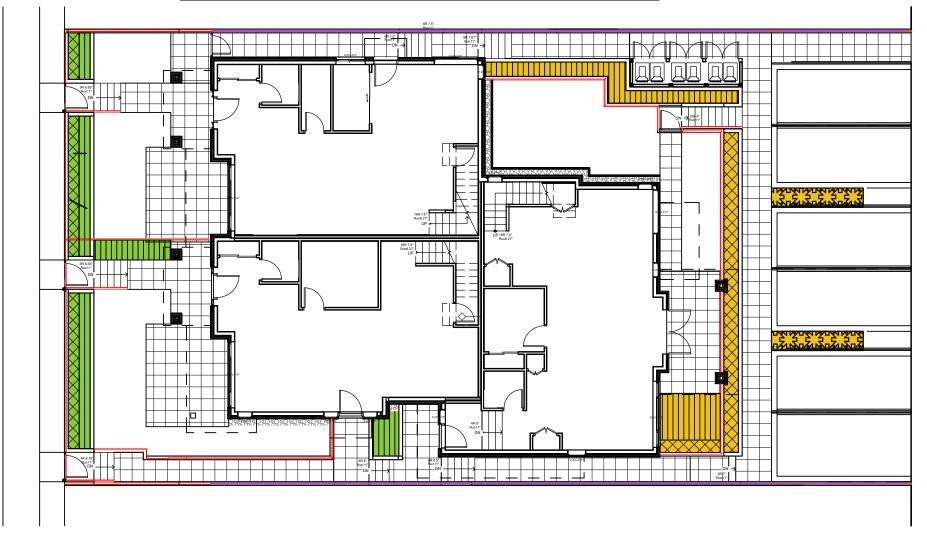

Suite C100 - 4185 Still Creek Drive Burnaby, British Columbia, V5C 6G9 p: 604 294-0011; f: 604 294-0022

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3	21.JAN.13	REVISE PER CITY COMMENTS
3 2	21.JAN.13 21.DEC.14	
_		REVISE PER CITY COMMENTS REVISE PER NEW SITE PLAN/COMMENTS REVISE PER CITY COMMENTS

TRIPLEX

21058-Triplex-3.ZIP



PLANTING

TYPES

SCALE: 1:200 DRAWN: RK

PLANT PALETTE FOR FULL SUN AREAS

STANDARD TREES



CARPINUS BETULUS 'FASTIGIATA' 10' W x 40' H




QUERCUS ROBUR ALBA 'SKINNY GENES'



FRAXINUS ANGUSTIFOLIA 'RAYWOOD' 25' W x 30' H



GINKGO BILOBA 'PRINCETON SENTRY' 20' W x 40' H

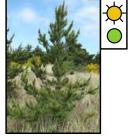

PINUS CONTORTA

ORNAMENTAL TREES




SYRINGA VULGARIS



CHIONANTHUS RETUSUS 10' W x 10' H



PARROTIA PERSICA 'VANESSA'

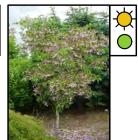

20' W x 20' H

PROPOSED SHRUBS & HEDGES





EUONYMUS 'COMPACTUS' 5' W x 5' H













SPIRAEA JAPONICA 'GOLDMOUND'



THUJA'SMARAGD'



CEANOTHUS VELUTINUS








ROSA GYMNOCARPA 4' W x 4' H

LEGEND



PROPOSED GRASSES/PERENNIALS/GROUNDCOVERS

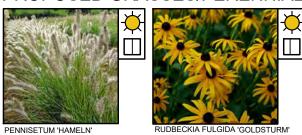



STIPA TENUISSIMA







SEMPERVIRENS 2' W x 3' H



CALAMAGROSTIS 'KARL FOERSTER' 3' W x 4' H



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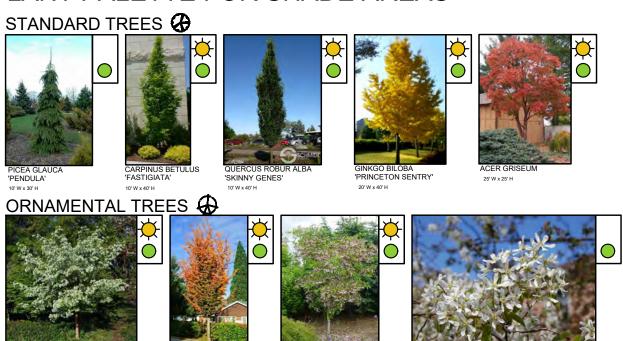
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3	21.JAN.13	REVISE PER CITY COMMENTS	
2	21.DEC.14	REVISE PER NEW SITE PLAN/COMMENTS	
1	21.DEC.01	REVISE PER CITY COMMENTS	

TRIPLEX

FULL SUN PLANT PALETTE



PLANT PALETTE FOR SHADE AREAS




STYRAX JAPONICUS

15' W x 15' H

PROPOSED SHRUBS & HEDGES



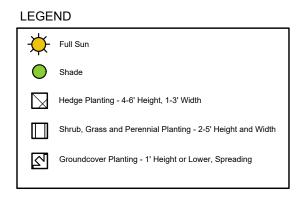

PROPOSED GRASSES/PERENNIALS/GROUNDCOVERS



21058-Triplex-3.ZI



10' W x 10' H

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TRIPLEX

SHADE PLANT PALETTE



 SCALE:
 1:200

 DRAWN:
 RK

 DESIGN:
 RK

 CHK'D:
 MCY

WING NUMBER:

...

PLANT SCHEDULE PMG PROJECT NUMBER: 21-058 S / O* C/E/D* **BOTANICAL NAME COMMON NAME** PLANTED SIZE / REMARKS **SPACING TREES ACER GRISEUM** PAPERBARK MAPLE 5CM CAL; 1.2M STD; B&B 4M O.C. D 3M O.C. AMELANCHIER CANADENSIS SERVICEBERRY 5CM CAL, 1M STD, B&B 3M O.C. CARPINUS BETULUS 'FASTIGIATA' PYRAMIDAL EUROPEAN HORNBEAM 5CM CAL, 1M STD, B&B 3M O.C. CHIONANTHUS RETUSUS FRINGE TREE 6CM CAL, 1.2M STD 3M O.C. FRAXINUS ANGUSTIFOLIA 'RAYWOOD' **RAYWOOD ASH** 5CM CAL; 1.2M STD; B&B D 4M O.C. GINKGO BILOBA 'PRINCETON SENTRY' PRINCETON SENTRY MAIDENHAIR 6CM CAL; 1.2M STD; B&B PARROTIA PERSICA 'VANESSA' 4M O.C. VANESSA PERSIAN IRONWOOD 6CM CAL, 1.2M STD PICEA GLAUCA 'PENDULA' WEEPING WHITE SPRUCE 2.5M HT; B&B 2M O.C. 4M O.C. PINUS CONTORTA SHORE PINE 2.5M HT; B&B D 2M O.C. QUERCUS ROBUR ALBA 'SKINNY GENES' FASTIGIATE ENGLISH OAK 6CM CAL; 1.2M STD; B&B 4M O.C. STYRAX JAPONICA 'SNOWCONE' SNOWCONE SNOWBELL 5CM CAL, 1M STD, B&B 3M O.C. SYRINGA VULGARIS COMMON TREE LILAC 5CM CAL, 1M STD, B&B **SHRUBS**

D	ARONIA MELANOCARPA 'AUTUMN MAGIC'	AUTUMN MAGIC CHOKEBERRY	#3 POT	1M O.C.
Е	ARBUTUS UNEDO 'COMPACTA'	COMPACT STRAWBERRY TREE	#3 POT	1M O.C.
D	BERBERIS THUNBERGII "AUREA NANA"	GOLDEN DWARF BARBERRY	#3 POT	1M O.C.
D	CEANOTHUS VELUTINUS	SNOWBRUSH	#3 POT	1M O.C.
D	CORNUS SERICEA 'KELSEYI'	DWARF KELSEY DOGWOOD	#3 POT	600MM O.C.
Е	ESCALLONIA 'NEWPORT DWARF'	COMPACT ESCALLONIA	#3 POT	900MM O.C.
D	EUONYMUS ALATA 'COMPACTUS'	COMPACT WINGED BURNING BUSH	#3 POT	1M O.C.
D	FOTHERGILLA MAJOR 'MOUNT AIRY'	MOUNT AIRY FOTHERGILLA	#3 POT	1M O.C.
D	HYDRANGEA PANICULATA 'LIMELIGHT'	LIMELIGHT HYDRANGEA; LIMEGREEN-PINK	#3 POT	1M O.C.
Е	ILEX CRENATA 'CONVEXA'	JAPANESE HOLLY	#3 POT	900MM O.C.
Е	LONICERA PILEATA	PRIVET HONEYSUCKLE	#2 POT	900MM O.C.
Е	MAHONIA AQUIFOLIUM 'COMPACTA'	COMPACT OREGON GRAPE	#3 POT	600MM O.C.
Е	NANDINA DOMESTICA 'GULF STREAM'	HEAVENLY BAMBOO; DWARF	#2 POT	900MM O.C.
D	PHYSOCARPUS OPULIFOLIUS 'DART'S GOLD'	GOLDEN NINEBARK	#3 POT	900MM O.C.
Е	POLYSTICHUM MUNITUM	SWORD FERN	#2 POT	900MM O.C.
Е	RHODODENDRON 'CUNNINGHAM'S WHITE'	RHODODENDRON; WHITE; L. MAY	#3 POT	1M O.C.
D	ROSA GYMNOCARPA	BALDHIP ROSE	#3 POT	900MM O.C.
Ε	SARCOCOCCA HOOKERIANA 'HUMILIS'	SWEETBOX	#2 POT	900MM O.C.
Е	SKIMMIA JAPONICA (90% MALE)	JAPANESE SKIMMIA	#2 POT	900MM O.C.
D	SPIRAEA JAPONICA 'GOLDMOUND'	DWARF GOLDMOUND SPIREA	#3 POT	600MM O.C.
D	SYMPHORICARPOS MOLLIS	SNOWBERRY	#3 POT	900MM O.C.
С	TAXUS X MEDIA 'HICKSII'	HICK'S YEW	1.2M HT; B&B	600MM O.C.
С	THUJA OCCIDENTALIS 'SMARAGD'	EMERALD GREEN CEDAR	1.5M HT; B&B	450MM O.C.
Е	VACCINIUM OVATUM	EVERGREEN HUCKLEBERRY	#2 POT	600MM O.C.

^{*}S / O INDICATES STANDARD OR ORNAMENTAL TREES

TRIPLEX

LANDSCAPE ARCHITECTS Itd.

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Burnaby, British Columbia, V5C 669
p: 604 254-04011; 604 249-0022

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3 21.14M 1.3 REVISE PER CITY COMMENTS RE
2 21.08C.14 REVISE PER NEW SITE PLANYCOMMENTS RE
1 21.08C.01 REVISE PER NEW SITE PLANYCOMMENTS RE
NO. DATE REVISION DESCRIPTION DR

PLANT SCHEDULE DATE: 21.1
SCALE: NTS
DRAWN: RK
DESIGN: RK
CHK'D: MC

CH DF



21058-Triplex-3.ZIP

^{*}C/E/D INDICATES CONIFEROUS OR EVERGREEN OR DECIDUOUS SPECIES

GRASSES

D	CALAMAGROSTIS ACUTIFLORA 'KARL FOERSTER'	FEATHER REED GRASS	#1 POT	450MM O.C.
Ε	CAREX OSHIMENSIS 'EVERGOLD'	EVERGOLD JAPANESE SEDGE	#1 POT	300MM O.C.
D	HAKONECHLOA MACRA 'AUREOLA'	HAKONE GRASS	#1 POT; 1 EYE	300MM O.C.
Е	HELICTOTRICHON SEMPERVIRENS	BLUE OAT GRASS	#1 POT	300MM O.C.
D	IMPERATA CYLINDRICA 'RED BARON'	BLOOD GRASS	#1 POT	300MM O.C.
D	PENNISETUM ALOPECUROIDES 'HAMELIN'	DWARF FOUNTAIN GRASS	#1 POT	300MM O.C.
D	STIPA TENUISSIMA	MEXICAN FEATHER GRASS	#1 POT	300MM O.C.

PERENNIALS

D	ASTILLBE ARENDSII	FALSE GOATSBEARD	#1 POT; 1 EYE	300MM O.C.
E	BRUNNERA MACROPHYLLA	SIBERIAN BUGLOSS	#1 POT; 1 EYE	300MM O.C.
D	HELLEBORUS X HYBRIDUS	HELLEBORE	#1 POT; 1 EYE	300MM O.C.
E	HEMEROCALLIS 'YELLOWSTONE'	DAYLILY; LIGHT YELLOW	#2 POT; 2-3 FAN	300MM O.C.
D	HEUCHERA 'BERRY SMOOTHIE'	ROSE PINK HEUCHERA	#1 POT	300MM O.C.
D	HOSTA 'AUGUST MOON'	HOSTA	#1 POT; 1 EYE	300MM O.C.
D	RUDBECKIA FULGIDA VAR SULLIVANTII `GOLDSTURM'	RUDBECKIA; YELLOW	#1 POT	300MM O.C.
E	SEDUM 'ANGELINA'	ANGELINA STONECROP	#1 POT	300MM O.C.

GROUNDCOVERS

ARCOSTAPHYLOS UVA URSI #1 POT; 1 EYE 300MM O.C. KINNICKINICK

*C/E/D INDICATES CONIFEROUS OR EVERGREEN OR DECIDUOUS SPECIES


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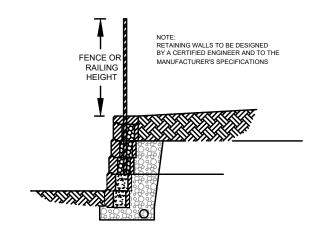
CLIENT:
CITY OF COQUITLAM

TRIPLEX

PLANT SCHEDULE

SCALE:



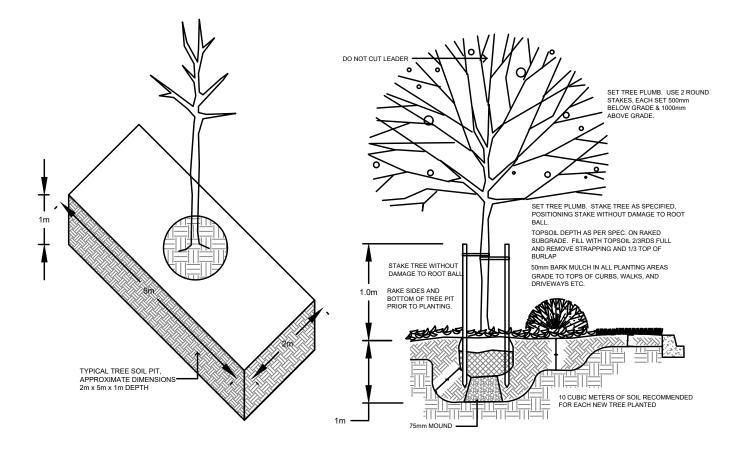


TREE PLANTING DETAIL


1:100

TYPICAL ALLAN BLOCK WALL DETAIL

MIN. 75mm OF COMPOSTED BARK MULCH AS PER SPECIFICATION APPLIED SPREAD ROOTS EVENLY OVER COMPACTED MOUND OF TOPSOIL. PRUNE ALL DAMAGED ROOTS LEAVING ROOT TIPS WITH CLEAN ENDS. FINISHED GRADE AS PER SPECIFICATION MULCH TO BE 75mm DEEP AT DRIP LINE. TAPERING TO 0mm AT TRUNK FLARE.
LOOSEN ROOT MASS PRIOR TO PLANTING.

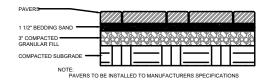

TYPICAL PAVERS ON GRADE DETAIL

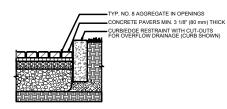

NOTES: 1. 2 3/8" (60 MM) THICK PAVERS MAY BE USED IN PEDESTRIAN APPLICATIONS. 2. NO. 2 STONE SUBBASE THICKNESS VARIES WITH DESIGN.

3. FOLLOW MANUFACTURER'S INSTALLATION RECOMMENDATIONS.
4. AS SITE CONDITIONS VARY, CONSULT A CIVIL ENGINEER FOR WALL/PAVING SUBGRADE.

BARE ROOT/CONTAINER SHRUB PLANTING

TYPICAL PERMEABLE PAVERS DETAIL

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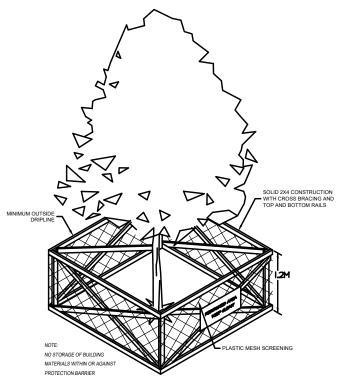
LANDSCAPE **DETAILS**

DRAWING TITLE:




SCALE: DRAWN-

21.APR.08



1 TREE PROTECTION DETAIL

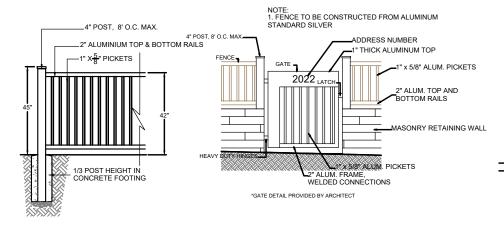


UNIT GATES UNIT FENCES


1.2m HEIGHT FENCE AND GATE



HUB SURFACE SYSTEMS STAMPED ASPHALT

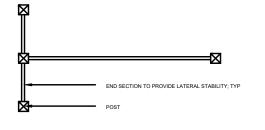

- ALL WOOD MEMBERS TO BE PRESSURE TREATED TO C.S.A. STANDARDS
- ALL WOOD MEMBERS TO BE PRESSURE TREATED TO CS.A. STANDARDS
 ALL HARDWARE TO BE HOT-DIPPED GALVANUZED
 APPLY TWO COATS OF STAIN TO MATCH BUILDING (TO BE APPROVED BY
 OWNER OR LANDSCAPE ARCHITECT)
 COAT ALL CUT SURPRACES WITH SIMILAR PRESERVATIVE AS ABOVE
 LENGTH AND PLACEMENT AS PER LANDSCAPE PLAN

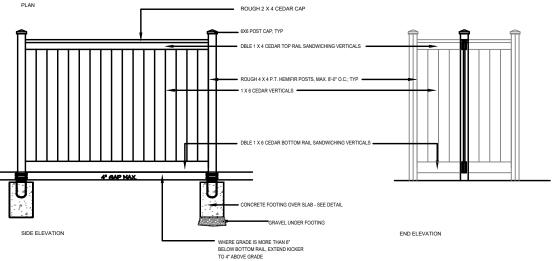

1.8m HEIGHT FENCE AND GATE

21058-Triplex-3.ZIP

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LANDSCAPE DETAILS 2

SCALE:

1.1 SCOPE OF WORK

- 1. Work includes supply of all related items and performing all operations necessary to complete the work in accordance with the drawings and specifications and generally consists of the following:
- Retention of Existing Trees where shown on drawings. 1.1.
- Finish Grading and Landscape Drainage. 1.2.
- Supply and placement of growing medium. 1.3.
- 1.4. Preparation of planting beds, supply of plant material and planting.
- 1.5. Preparation of lawn areas, supply of materials and sodding.
- Supply and placement of bark mulch.
- 1.2 Growing Medium: Conform to Canadian Landscape Standard for definitions of imported and on-site topsoil.

TABLE ONE: PROPERTIES OF GROWING MEDIUM FOR LEVEL 2 GROOMED AREAS Canadian System of Soil Classification Textural Class: "Loamy Sand" to "Sandy Loam".

Applications	Planting Areas		
	and Planters		
Growing Medium Types	2P		
Texture Percent O	Of Dry Weight of Total Growing Medium		
Coarse Gravel: larger than 25mm	0 - 1%		
All Gravel: larger than 2mm	0 - 5%		
Percent Of Dry Weigh	Percent Of Dry Weight of Growing Medium Excluding Gravel		
Sand: larger than 0.05mm smaller than 2.0mm	40 - 80%		
Silt: larger than 0.002mm smaller than 0.05mm	10 - 25%		
Clay: smaller than 0.002mm	0 - 25%		
Clay and Silt Combined	maximum 35%		
Organic Content (coast):	10 - 20%		
Organic Content (interior):	15 - 20%		
Acidity (pH):	4.5 - 6.5		

1.3 RETENTION OF EXISTING TREES

- .1 Prior to any work on site protect individual trees or plant groupings indicated as retained on landscape plans as vegetation retention areas.
- .2 A physical barrier must be installed to delineate clearing boundaries. Refer to physical barrier detail. If detail not provided, comply with local municipal requirements.
- .3 No machine travel, storage, or parking within vegetation retention areas or under crowns of trees to be retained is allowed.
- .4 No excavations, drain or service trenches nor any other disruption shall be permitted within vegetation retention areas.
- .5 Do not cut branches or roots of retained trees.

1.4 GRADES

.1 Eliminate standing water from all finished grades. Provide a smooth, firm and even surface in paved areas.

1.5 LAWN AREAS - SODDING

- .1 Specified Turfgrass for sod lawn areas includes Kentucky Blue for sun and Fescues for shade.
- .2 Sodding: Prepare a smooth, firm, even surface for laying sod. Lay sod staggered with sections closely butted, without overlapping or gaps, smooth and even with adjoining areas and roll lightly. Water to obtain moisture penetration of 3" to 4" (7 - 10cm).

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LANDSCAPE **SPECIFICATIONS** SCALE:

21058-Triplex-3.ZIF

1.6 PLANTS AND PLANTING

- .1 Conform to planting layout as shown on Landscape Plans.
- .2 Make edge of beds with smooth clean defined lines.
- .3 Standards:
 - .1 Refer to Plant Schedule for specific plant and container sizes and comply with requirements.
 - .2 Plant material obtained from areas with less severe climatic conditions shall be grown to withstand the site climate.
- .4 Plant Species & Location:
 - .4.1 Plants shall be true to name and of the height, caliper and size of root ball as shown on the landscape/site plan plant schedule. Caliper of trees is to be taken 6" (15cm) above grade.
 - .4.2 Plant all specified species in the location as shown on the landscape drawings.
- .5 Excavation:
 - .5.1 Trees and large shrubs: Excavate a saucer shaped tree pit to the depth of the rootball and to at least twice the width of the rootball. Assure that finished grade is at the original grade the tree was grown at.
- .6 Drainage of Planting Holes:
 - .6.1 Provide drainage of planting pits where required. ie. on sloped conditions, break out the side of the planting pit to allow drainage down slope; and in flat conditions, mound to raise the rootball above impervious layer.
- .7 Planting and Fertilizing Procedures:
 - .7.1 Plant all trees and shrubs with the roots placed in their natural growing position. If burlapped, loosen around the top of the ball and cut away or fold under. Do not pull burlap from under the ball. Carefully remove containers without injuring the rootballs. After settled in place, cut twine. For wire baskets, clip and remove top three rows of wire.
 - .7.2 Fill the planting holes by gently firming the growing medium around the root system in 6" (15cm) layers. Settle the soil with water. Add soil as required to meet finish grade. Leave no air voids. When 2/3 of the topsoil has been placed, apply fertilizer as recommended by the required soil test at the specified rates.
 - .7.3 Where planting is indicated adjacent to existing trees, use special care to avoid disturbance of the root system or natural grades of such trees.
 - .7.4 Where trees are in lawn areas, provide a clean cut mulched 900mm (3 ft.) diameter circle centered on the tree.
- .8 Staking of Trees:
 - .8.1 Use two 2"x2"x5' stakes, unless superseded by municipal requirements. Set stakes minimum 2 ft. in soil. Do not drive stake through rootball.
 - .8.2 Leave the tree carefully vertical.
 - .8.3 Tie with pre-approved commercial, flat woven polypropylene fabric belt, minimum width 19mm (3/4"). Approved product: ArborTie available from DeepRoot.
 - .8.4 Coniferous Trees over 6 ft. height: Guy with three 2-strand wires (11 gauge). Drive three stakes equidistant around the tree completely below grade.
- .9 Pruning:
 - .9.1 Limit pruning to the minimum necessary to remove dead or injured branches. Preserve the natural character of the plants, do not cut the leader. Use only clean, sharp tools. Make all cuts clean and cut to the branch collar leaving no stubs. Shape affected areas so as not to retain water. Remove damaged material.
- .10 Mulching:
 - .10.1 Mulch all planting areas with an even layer of mulch to 2-1/2 3" (65 75mm) depth. Confirm placement of mulch in areas labeled "Groundcover Area" on drawings. Mulch a 3 ft. (900mm) diameter circle around trees in lawn areas, leave a clean edge.

1.7 ESTABLISHMENT MAINTENANCE

.1 Required maintenance of the landscape includes watering, weeding, mowing, leaf removal and fertilization.

PANDSCAPE ARCHITECTS (III)

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3 21.14N.13 REVISE PER CITY COMMENTS RV
2 21.0C.14 REVISE PER NEW SITE PLANC/COMMENTS RV
1 21.0C.01 REVISE PER NEW SITE PLANC/COMMENTS RV
NO. DATE REVISION DESCRIPTION DR.

TRIPLEX

DRAWING TITLE:

DR/ DES

SCALE: 1:20
DRAWN: RK
DESIGN: RK
CHK'D: MC

DRAWING NU

RAWING NUMBER: